**ABBREVIATIONS** 

### WEBER STATE UNIVERSITY LIND LECTURE HALL PARTIAL REMODEL

OGDEN, UTAH

UTAH STATE DIVISION OF FACILITIES CONSTRUCTION & MANAGEMENT - DFCM PROJECT NO. 04040810

### BID PACKAGE NO. 2: CONSTRUCTION SET APRIL 20, 2006

APPLICABLE CODES	INDEX TO DRA	WINGS	_
Year Year   Year   International Building Code	<u>GENERAL</u> Gl001	SHEET INDEX AND GENERAL INFORMATION	
International Mechanical Code <u>2003</u> Uniform Building Code for International Plumbing Code <u>2003</u> Building Conservation <u>1997 (for stair railings)</u> International Fire Code 2003 NFPA 13 & 14 ADA Accessibility	ARCHITECTURA		
International Energy Guidelines1994 Conservation Code2003 International			
Conservation Code <u>2003</u> International Fuel & Gas Code <u>2003</u>		SITE PLAN GROUND FLOOR PLAN	
A. Occupancy and Group		FIRST FLOOR PLAN	
Change in Use: Yes NoX Mixed Occupancy: YesX _ No		SECOND FLOOR PLAN PARTIAL GROUND & FIRST FLOOR CEILING PLAN	
B. Seismic Design Category: Design Wind Speed: mph		SECOND FLOOR CEILING PLAN	
C. Type of Construction (circle one):		ENLARGED PLAN & SECTION ENLARGED STAIRS & SECTION	
	AE403	RESTROOM ELEVATION	
$\begin{array}{c ccccccccccccccccccccccccccccccccccc$		CEILING DETAILS FINISH SCHEDULE	С
separation distance (in hours):	MECHANICAL		
North:0 South:0 East:0 West:0			
E. Mixed Occupancies: B,A-3	MH001 MH200	LEGEND AND ABBREVIATIONS SHEET  GROUND FLOOR MECHANICAL REMODEL PLAN  On the state of the state	
Nonseparated Uses: N/A		FIRST FLOOR MECHANICAL REMODEL PLAN  FIRST FLOOR MECHANICAL REMODEL PLAN	
F: Sprinklers:		SECOND FLOOR MECHANICAL REMODEL PLAN	
Required: NO Provided: NO Type of Sprinkler System: N/A		MECHANICAL DETAILS	
		MECHANICAL DETAILS MECHANICAL SCHEDULES	
Number of Stories: <u>3</u> Building Height: <u>38'-8"</u>	PL200	GROUND FLOOR PLUMBING REMODEL PLAN	
H: Actual Area per Floor (square feet): <u>G = 31,882 SF, 1ST = 32,856 SF, 2ND = 10,460 SF</u>		FIRST FLOOR PLUMBING REMODEL PLAN	
Tabular Area: _with increase = 113,750 S.F.		SECOND FLOOR PLUMBING REMODEL PLAN PLUMBING DETAILS	
J: Area Modifications:		PLUMBING SCHEDULES  PLUMBING SCHEDULES	
d) Unlimited Area Building: Yes No _X Code Section:	ELECTRICAL		
K. Fire Resistance Rating Requirements for Building Elements (hours).	EE002	GENERAL NOTES & SCHEDULES POWER SINGLE LINE DIAGRAM & DETAILS	
Element Hours Assembly Listing Element Hours Assembly Listing	DEE101-ALT EL100	ALT. FIRST FLOOR DEMOLITION PLAN ELECTRICAL  GROUND FLOOR PLAN - LIGHTING & ELECTRICAL  1. STATE OF THE PLAN - LIGHTING & ELECTRICAL	
Exterior Bearing Walls 0 Floors - Ceiling Floors 0	EL101	FIRST FLOOR PLAN LIGHTING	
Interior Bearing Walls  Exterior Non-Bearing Walls  0  Exterior Doors and Windows  0  0	EL101-ALT	ALTERNATE FIRST FLOOR PLAN - LIGHTING	
Structural Frame  O Shaft Enclosures  1 UL-U469	EL102 EP101	SECOND FLOOR PLAN LIGHTING FIRST FLOOR PLAN ELECTRICAL	
Partitions - Permanent Fire Barriers  O Fire Walls Fire Partitions (Corr.)  Smoke Partitions	EP102	SECOND FLOOR PLAN ELECTRICAL FIRST FLOOR PLAN SYSTEMS	
L. Design Occupant Load: *= NO CHANGE IN OCC. LOAD OR EXIT WIDTH.  Exit Width Required: Exit Width Provided:	ES102	SECOND FLOOR PLAN SYSTEMS	В
M. Minimum Number of Required Plumbing Facilities *: NUMBER OF EXIST. FIXTURES			
TO REMAIN THE SAME  a) Water Closets - Required (m) . (f) . Provided (m) (f)			
b) Lavatories - Required (m) (f) Provided (m) (f)			
c) Bath Tubs or Showers: d) Drinking Fountains: Service Sinks:			
FOOTNOTES:			
1) In case of conflict with the U.S. Department of Justice Federal Registers Parts through ▼ - ADA Guidelines and specific reference to the International Building Code Accessibility Chapters, the more restrictive requirement shall govern.			
Additional Code Information shall be provided at the discretion of the Building     Official for Complex Buildings. Including, but not limited to:			
a) Performance Based Criteria.			
b) Means or Egress Analysis. c) Fire Assembly Locator Sheet.			
d) Exterior and Interior Accessibility Route. e) Fire Stopping, Including Tested Design Number.			
3) Renovation work is necessitated by total building hazardous materials abatement			
(covered in Bid Package No. 1), and partial accessibility upgrade. Only those areas affected by the abatement are being remodeled.			
	VICINITY MAP		
	PROJECT LOCATION: BUILDING 7		
			A
			1
	CONSULTANTS		
	MECHANICAL	ELECTRICAL	
	OLVIN ENGINEERING ASSOCIATE	S, INC. ELECTRICAL CONSULTING ENGINEERS	
	44 WEST 300 NORTH, STE. 200	939 SOUTH WEST TEMPLE	
	ALT LAKE CITY, UT 84103	SALT LAKE CITY, UT 84101	1

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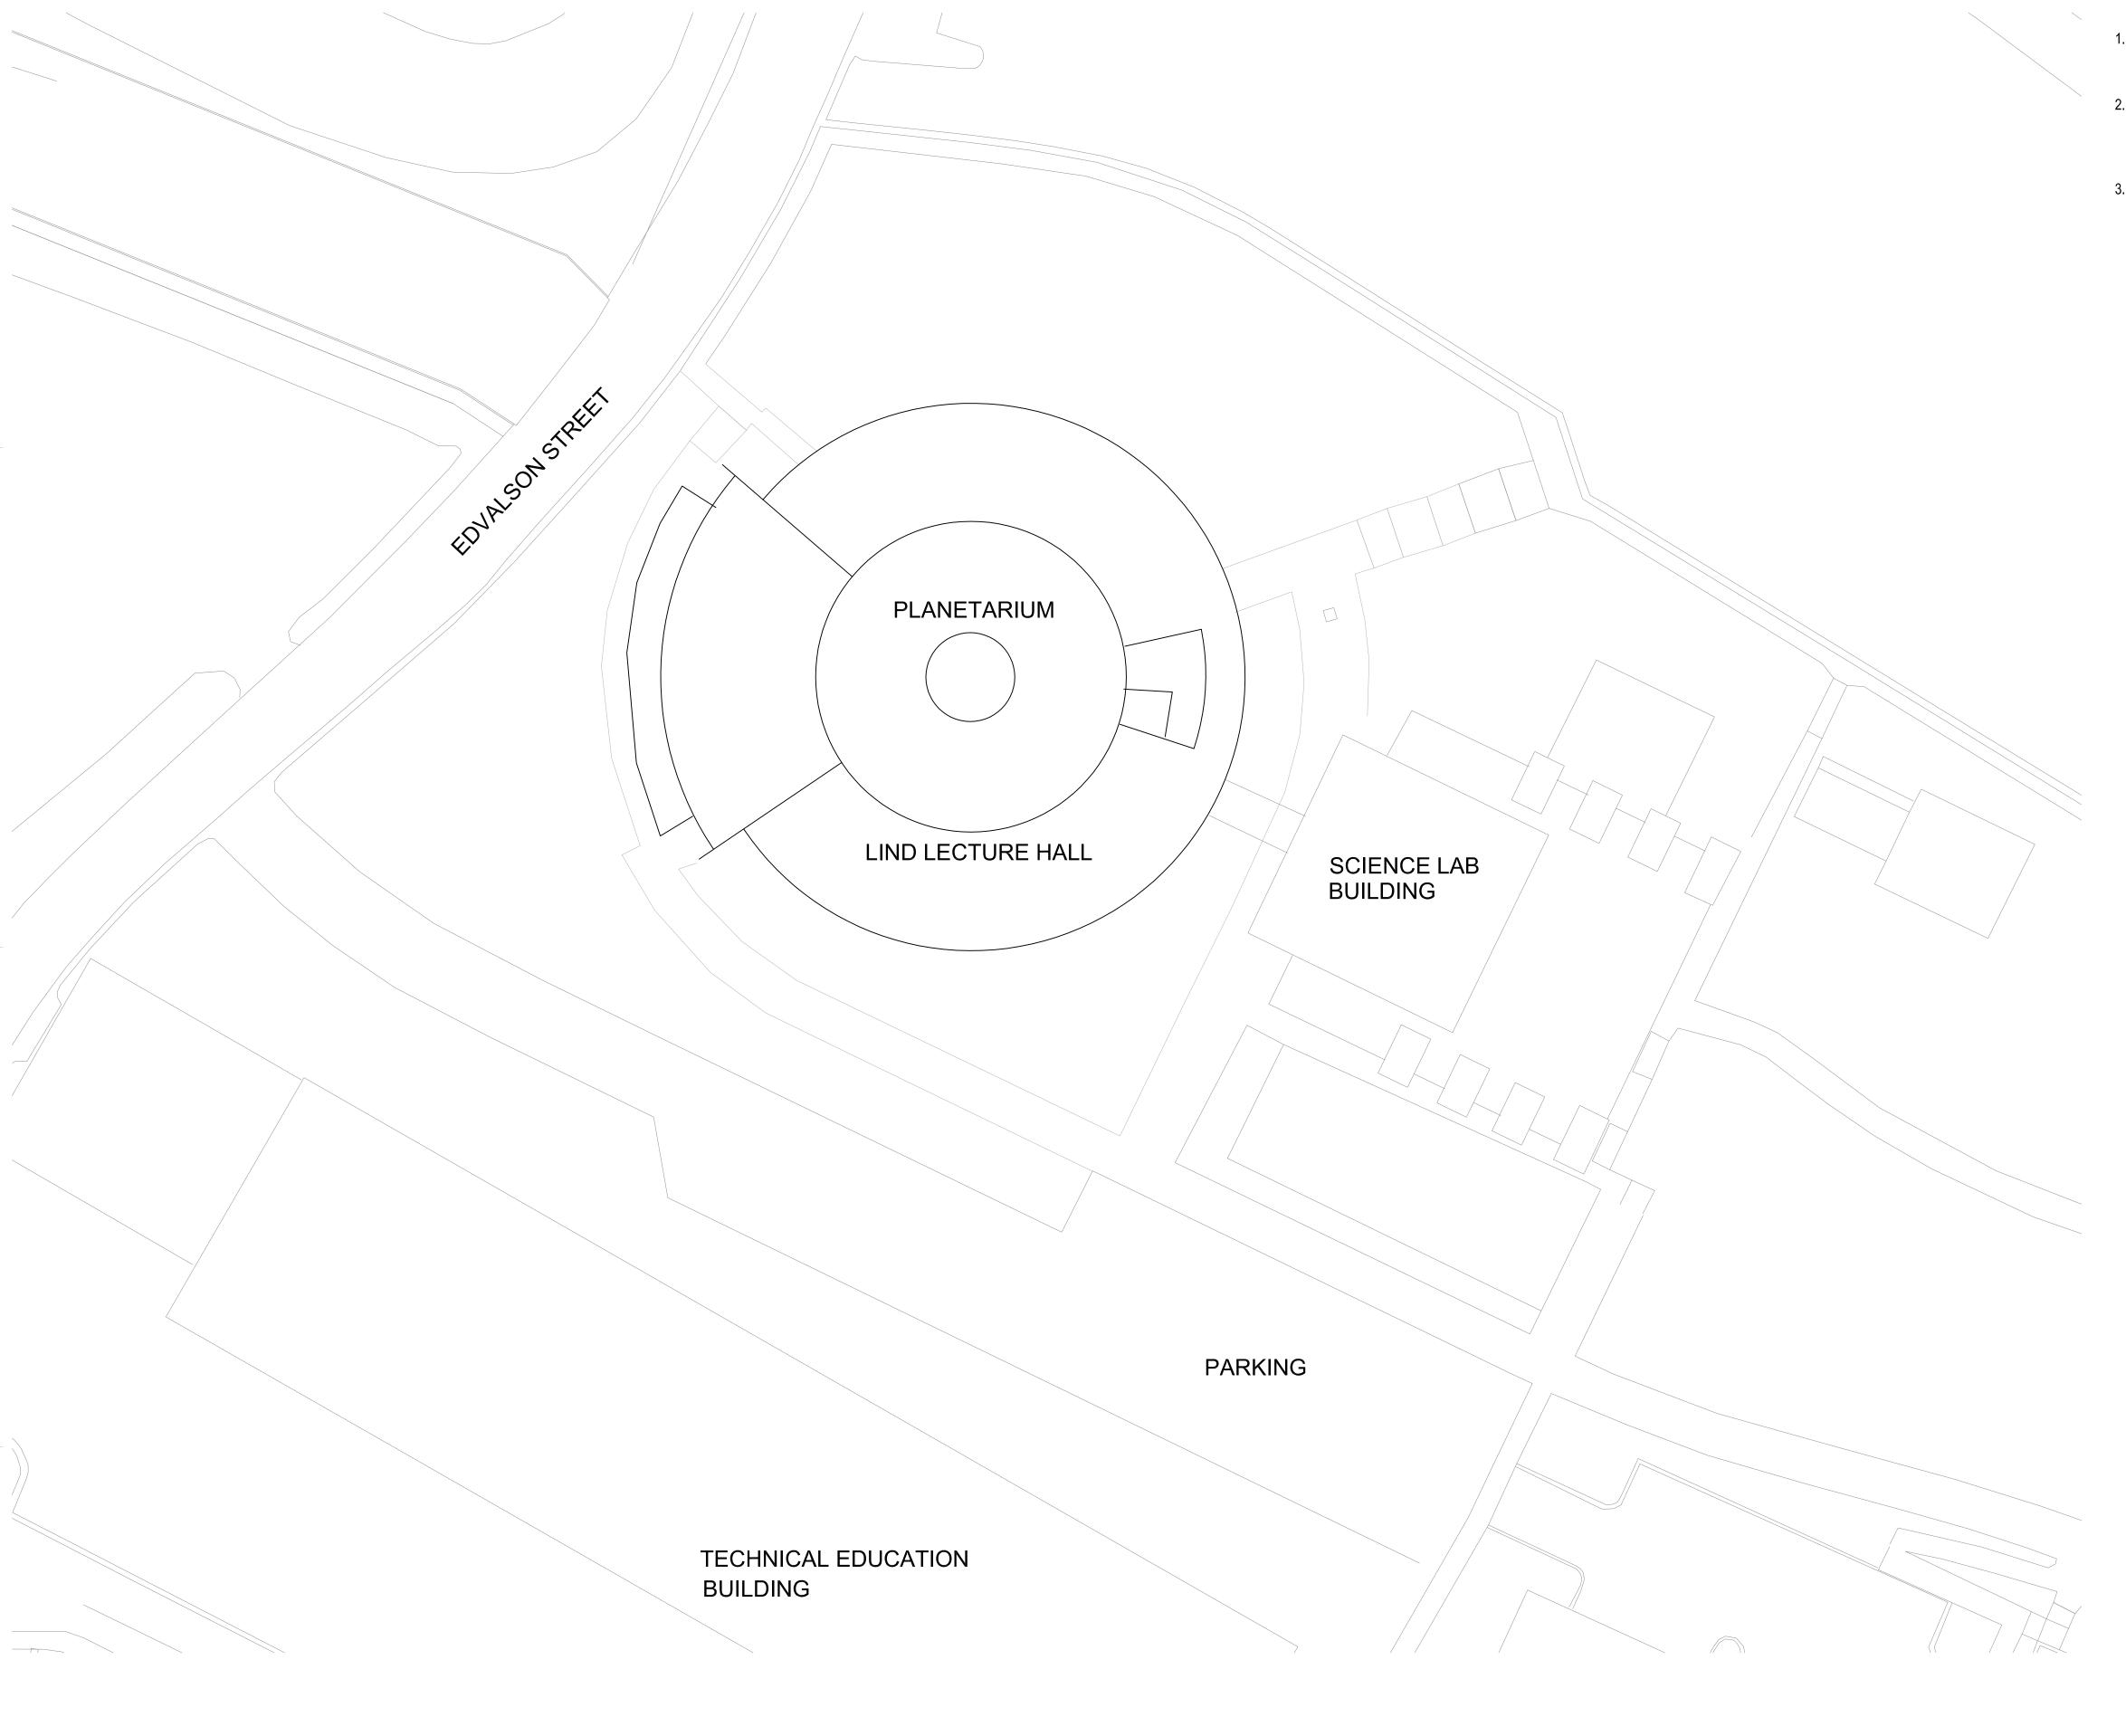
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SHEET INDEX AND GENERAL INFORMATION

CONSTRUCTION SET

SHEET NUMBER

GI001



SITE PLAN

SCALE: 1/16" = 1'-0"

### **GENERAL NOTES:**

- ALL CONSTRUCTION OPERATIONS SHALL MINIMIZE DAMAGE TO THE EXISTING SITE AND UNDERGROUND IMPROVEMENTS.
- 2. ALL EXISTING SITE IMPROVEMENTS DAMAGED BY CONSTRUCTION OPERATIONS SHALL BE REPAIREDTO EXISTING CONDITIONS AS PART OF THIS CONTRACT.
- CONTRACTOR SHALL BE FAMILIAR WITH ALL EXISTING UTILITIES AND BE RESPONSIBLE FOR PROTECTING THE SAME.



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LIND LECTURE HALL REMODEL WEBER STATE UNIVERSITY OGDEN CAMPUS OGDEN, UTAH

MHTN PROJECT NO.

DFCM PROJECT NO. 2005605

DRAWN BY: RAL CHECKED BY: MG

ISSUED:

NO. DATE DESCRIPTION

1 4.20.06 BID PACKAGE #2

REVISIONS:

NO. DATE DESCRIPTION

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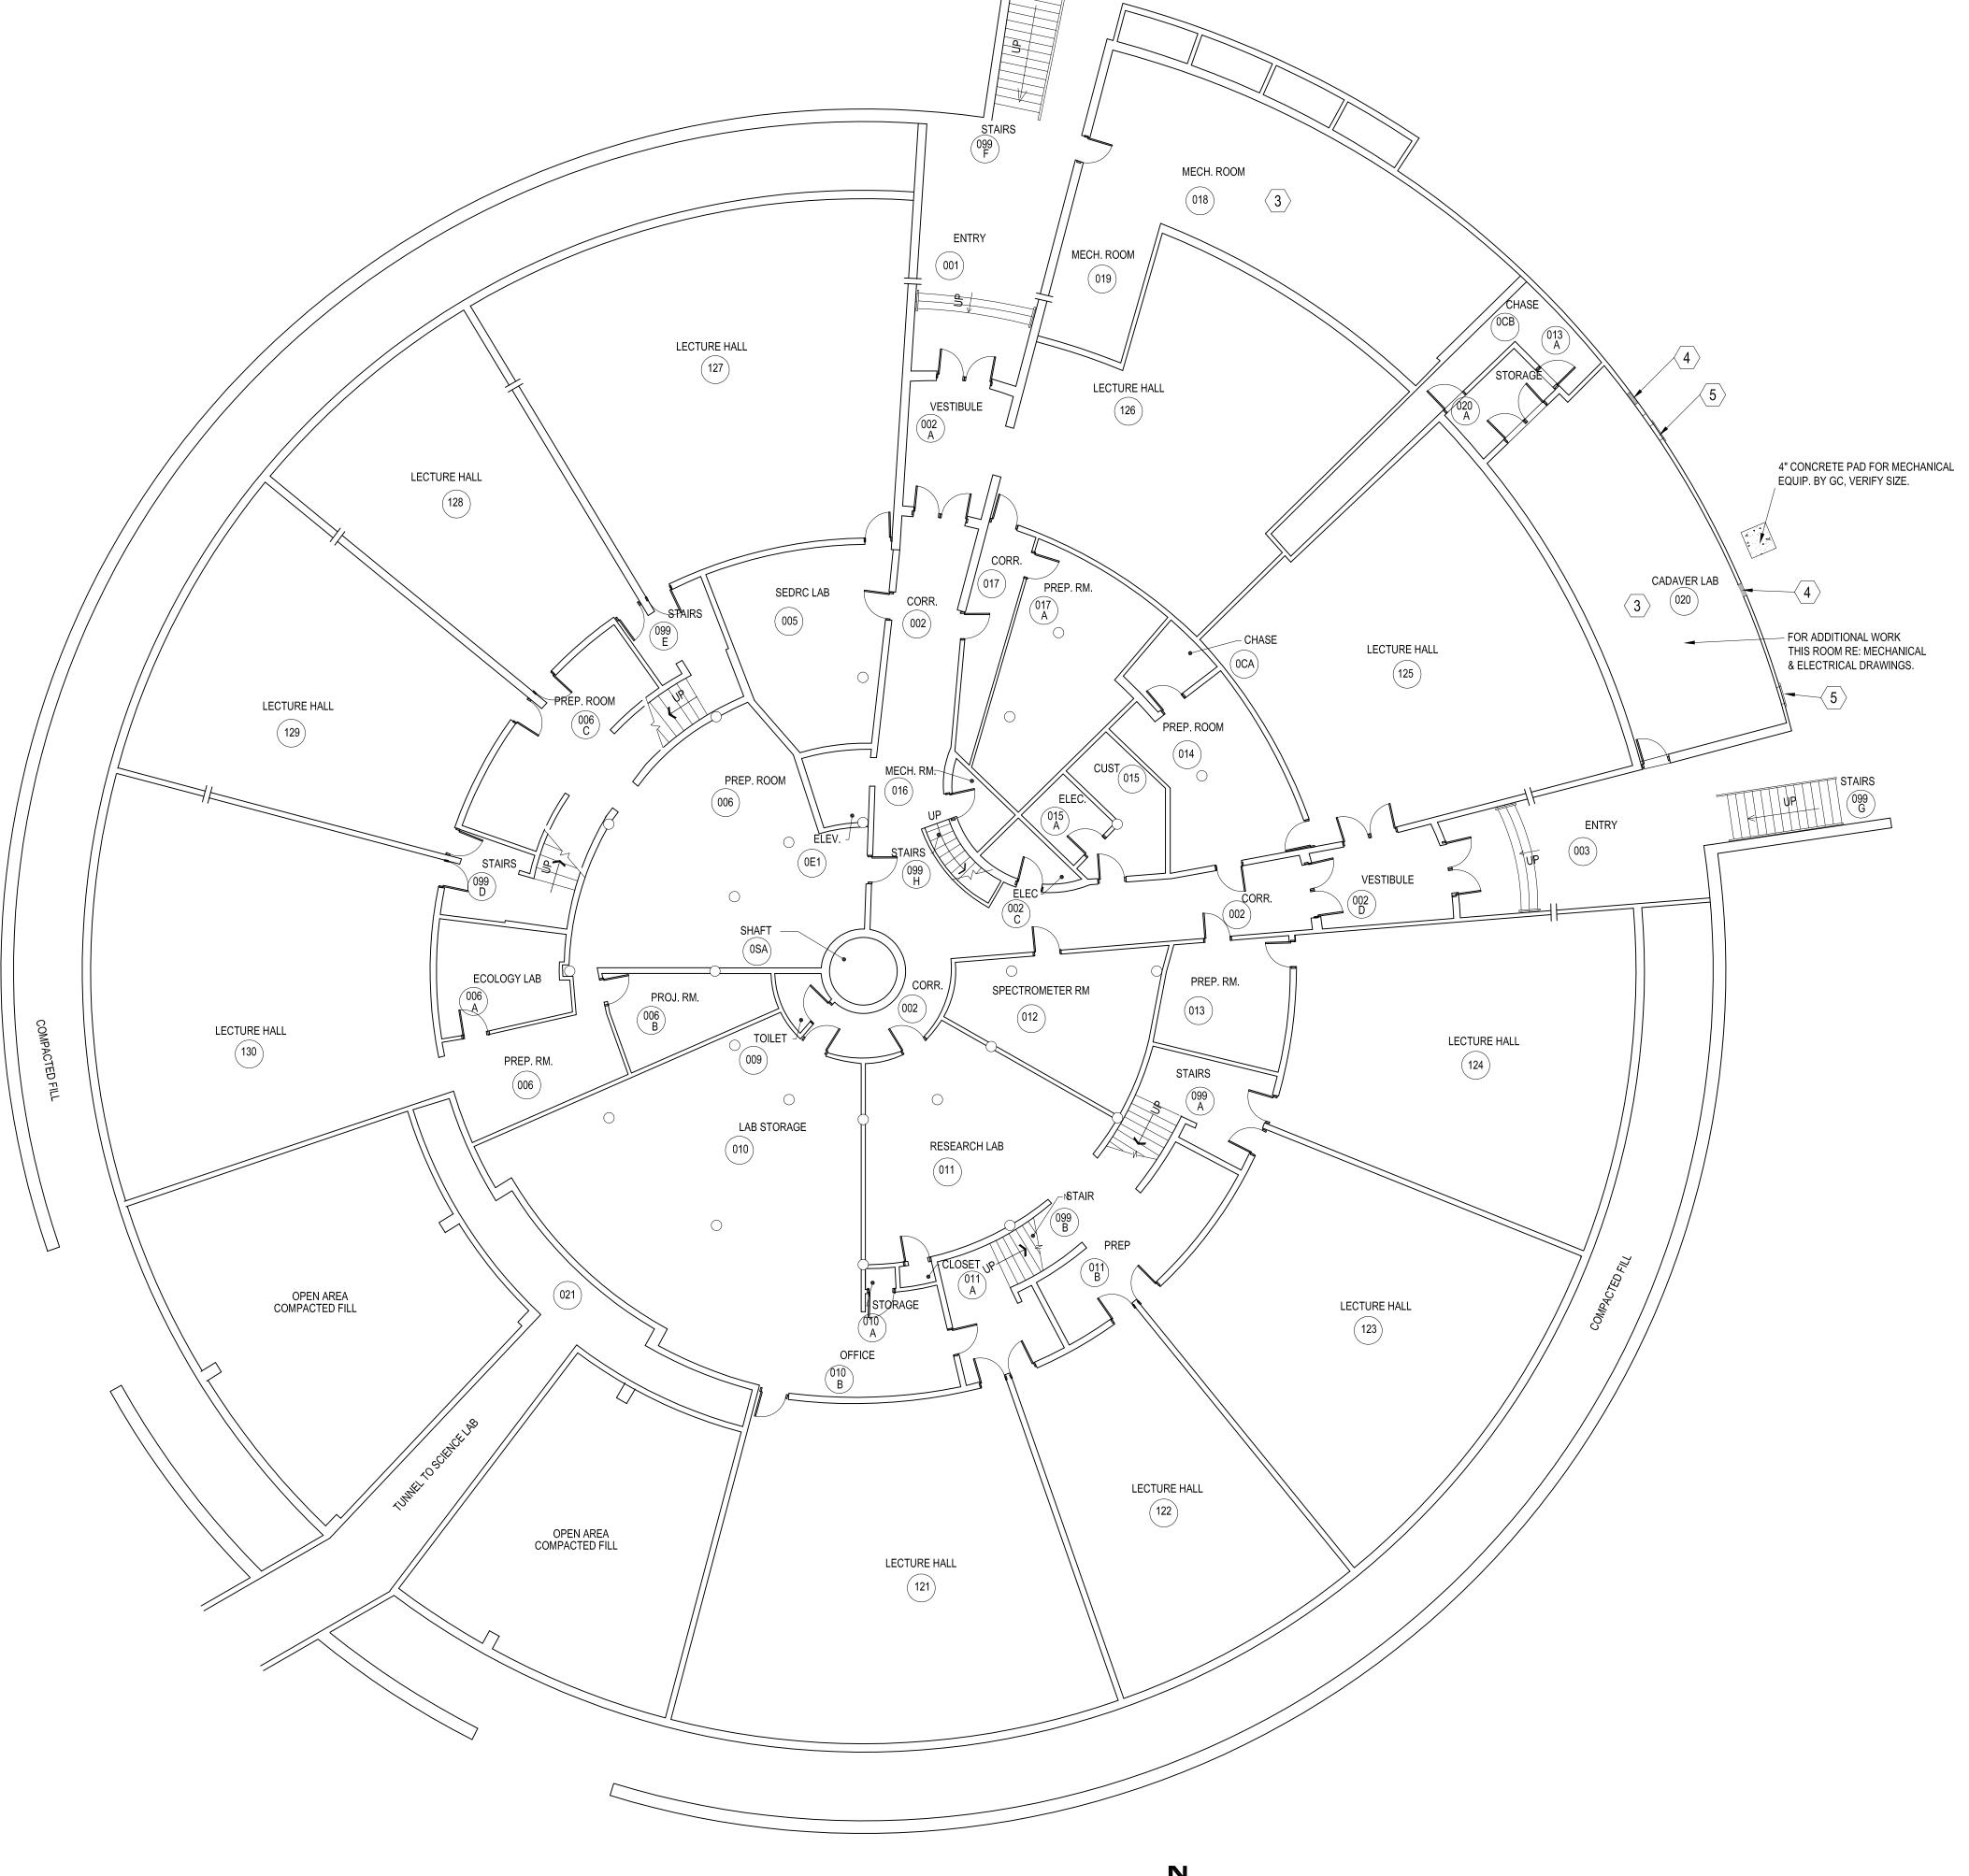
A DESCRIPTION

SITE PLAN

CONSTRUCTION SET

SHEET NUMBER

AS101



GROUND FLOOR PLAN

SCALE: 3/32" = 1'-0"

### REMODELING NOTES

1. CONTRACTOR IS RESPONSIBLE FOR VERIFYING ALL DIMENSIONS AND CONDITIONS AT THE SITE BEFORE SUBMITTING A BID OR PROCEEDING WITH ANY PORTION OF THE WORK

2. WHENEVER QUESTIONS ARISE OR CONDITIONS ARE ENCOUNTERED WHICH ARE NOT COVERED BY OR ARE IN CONFLICT WITH THE CONTRACT DOCUMENTS, CONSULT WITH THE ARCHITECT PRIOR TO TAKING ANY FURTHER ACTION.

3. CUT AND PATCH EXISTING BUILDING CONSTRUCTION AS REQUIRED. CUTTING AND DRILLING OF STRUCTURAL MEMBERS NOT DETAILED REQUIRES THE WRITTEN PERMISSION OF THE ARCHITECT.

4. THE CONTRACTOR SHALL COORDINATE PHASING & TIMING OF THE WORK WITH THE OWNER AND ARCHITECT TO MEET THE OWNERS SCHEDULE.

5. ALL CONSTRUCTION ACTIVITY IS TO BE CONTAINED WITHIN CONSTRUCTION BARRICADES OR FENCES. CONTRACTORS SHALL PROTECT OWNERS EXISTING CONSTRUCTION ADJACENT TO NEW CONSTRUCTION. AFTER WORK OF THIS CONTRACT, CLEAN AND RETURN TO ACCEPTABLE CONDITION EXISTING AREAS EFFECTED BY THE WORK TO THE OWNERS SATISFACTION.

6. PAINT ALL EXISTING WALLS WHERE EFFECTED BY DEMOLITION AND NEW CONSTRUCTION.

7. PAINT ALL NEW PIPING AND CONDUIT WHERE EXPOSED.

8. SUPPORT AND PROTECT EXISTING TO REMAIN SIGNAGE, FIRE ALARM SYSTEMS, LIGHTING, ETC. DURING CONSTRUCTION, UNLESS OTHERWISE NOTED.

9. PATCH OPENINGS THAT REMAIN AFTER REMOVAL / DEMOLITION OF MECHANICAL & ELECTRICAL DEVICES, WITH MATERIALS AND FINISH TO MATCH ADJACENT SURFACES.

10. IN-PLACE PROTECTTION FOR DISPLAYS & MURALS TO REMAIN DURING CONSTRUCTION. REMOVE AND PATCH/FINISH ANCHORAGE POINTS AND ALL PROTECTIVE COVERINGS.

### GENERAL CONSTRUCTION NOTES

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2. CONTRACTOR SHALL NOT SCALE DRAWINGS, WRITTEN DIMENSIONS SHALL ALWAYS GOVERN. CONTRACTORS REQUIRING DIMENSIONS NOT NOTED SHALL CONTACT THE ARCHITECT PROJECT MANAGER FOR SUCH INFORMATION PRIOR TO PROCEEDING WITH THE WORK IN QUESTION.

3. PROTECT ALL EXISTING SURFACES, EQUIPMENT, ETC. THE CONTRACTOR SHALL REPAIR AND MAKE GOOD ANY DAMAGE TO ADJOINING SURFACES OR AREAS NOT PART OF THIS CONTRACT AT NO COST TO THE OWNER.

4. MAINTAIN A SAFE AND CLEAR ACCESS WAY AT ALL TIMES THROUGH WALKWAYS, DRIVE APPROACHES AND MAIN TRAFFIC AREAS.

5. PROVIDE DUST, WEATHER, AND SECURITY PROTECTION TO AREAS STILL IN USE DURING THE CONSTRUCTION PHASE. PROVIDE SECURE BARRICADES BETWEEN ACTIVE PEDESTRIAN WALKWAYS AND CONSTRUCTION ACTIVITES.

6. DEBRIS SHALL BE REMOVED FROM SITE DAILY OR AS DIRECTED BY THE WSU PROJECT MANAGER.

7. MOST, BUT NOT ALL UTILITIES ARE SHOWN IN THEIR APPROXIMATE LOCATION ON THE DRAWINGS. THE CONTRACTOR SHALL INFORM THE WSU PROJECT MANAGER 48 HOURS PRIOR TO ANY ACTIVITIES THAT MIGHT AFFECT THESE UTILITIES. IF DAMAGE TO EXISTING UTILITIES IS CAUSED AS A RESULT OF THE CONTRACTOR'S OPERATIONS, THE UTILITIES SHALL BE IMMEDIATELY REPAIRED TO THE SATISFACTION OF THE OWNER AT THE EXPENSE OF THE CONTRACTOR.

### **KEY NOTES**

- 1 REMOVE PROTECTIVE BARRIERS AFTER COMPLETION OF CONSTRUCTION.
- 2 AUTO DOOR OPERATOR ACTIVATOR
- FOR ADDITIONAL WORK THIS ROOM RE: MECHANICAL & ELECTRICAL DRAWINGS
- PATCH WALL OPENING WITH SALVAGED BRICK, TOOTHED IN PLACE, CMU BACK-UP, PLASTER INTERIOR.
- SAWCUT BRICK TO PLACE NEW LOUVERS, PROVIDE STEEL ANGLE LINTEL, RE: A4/AE501



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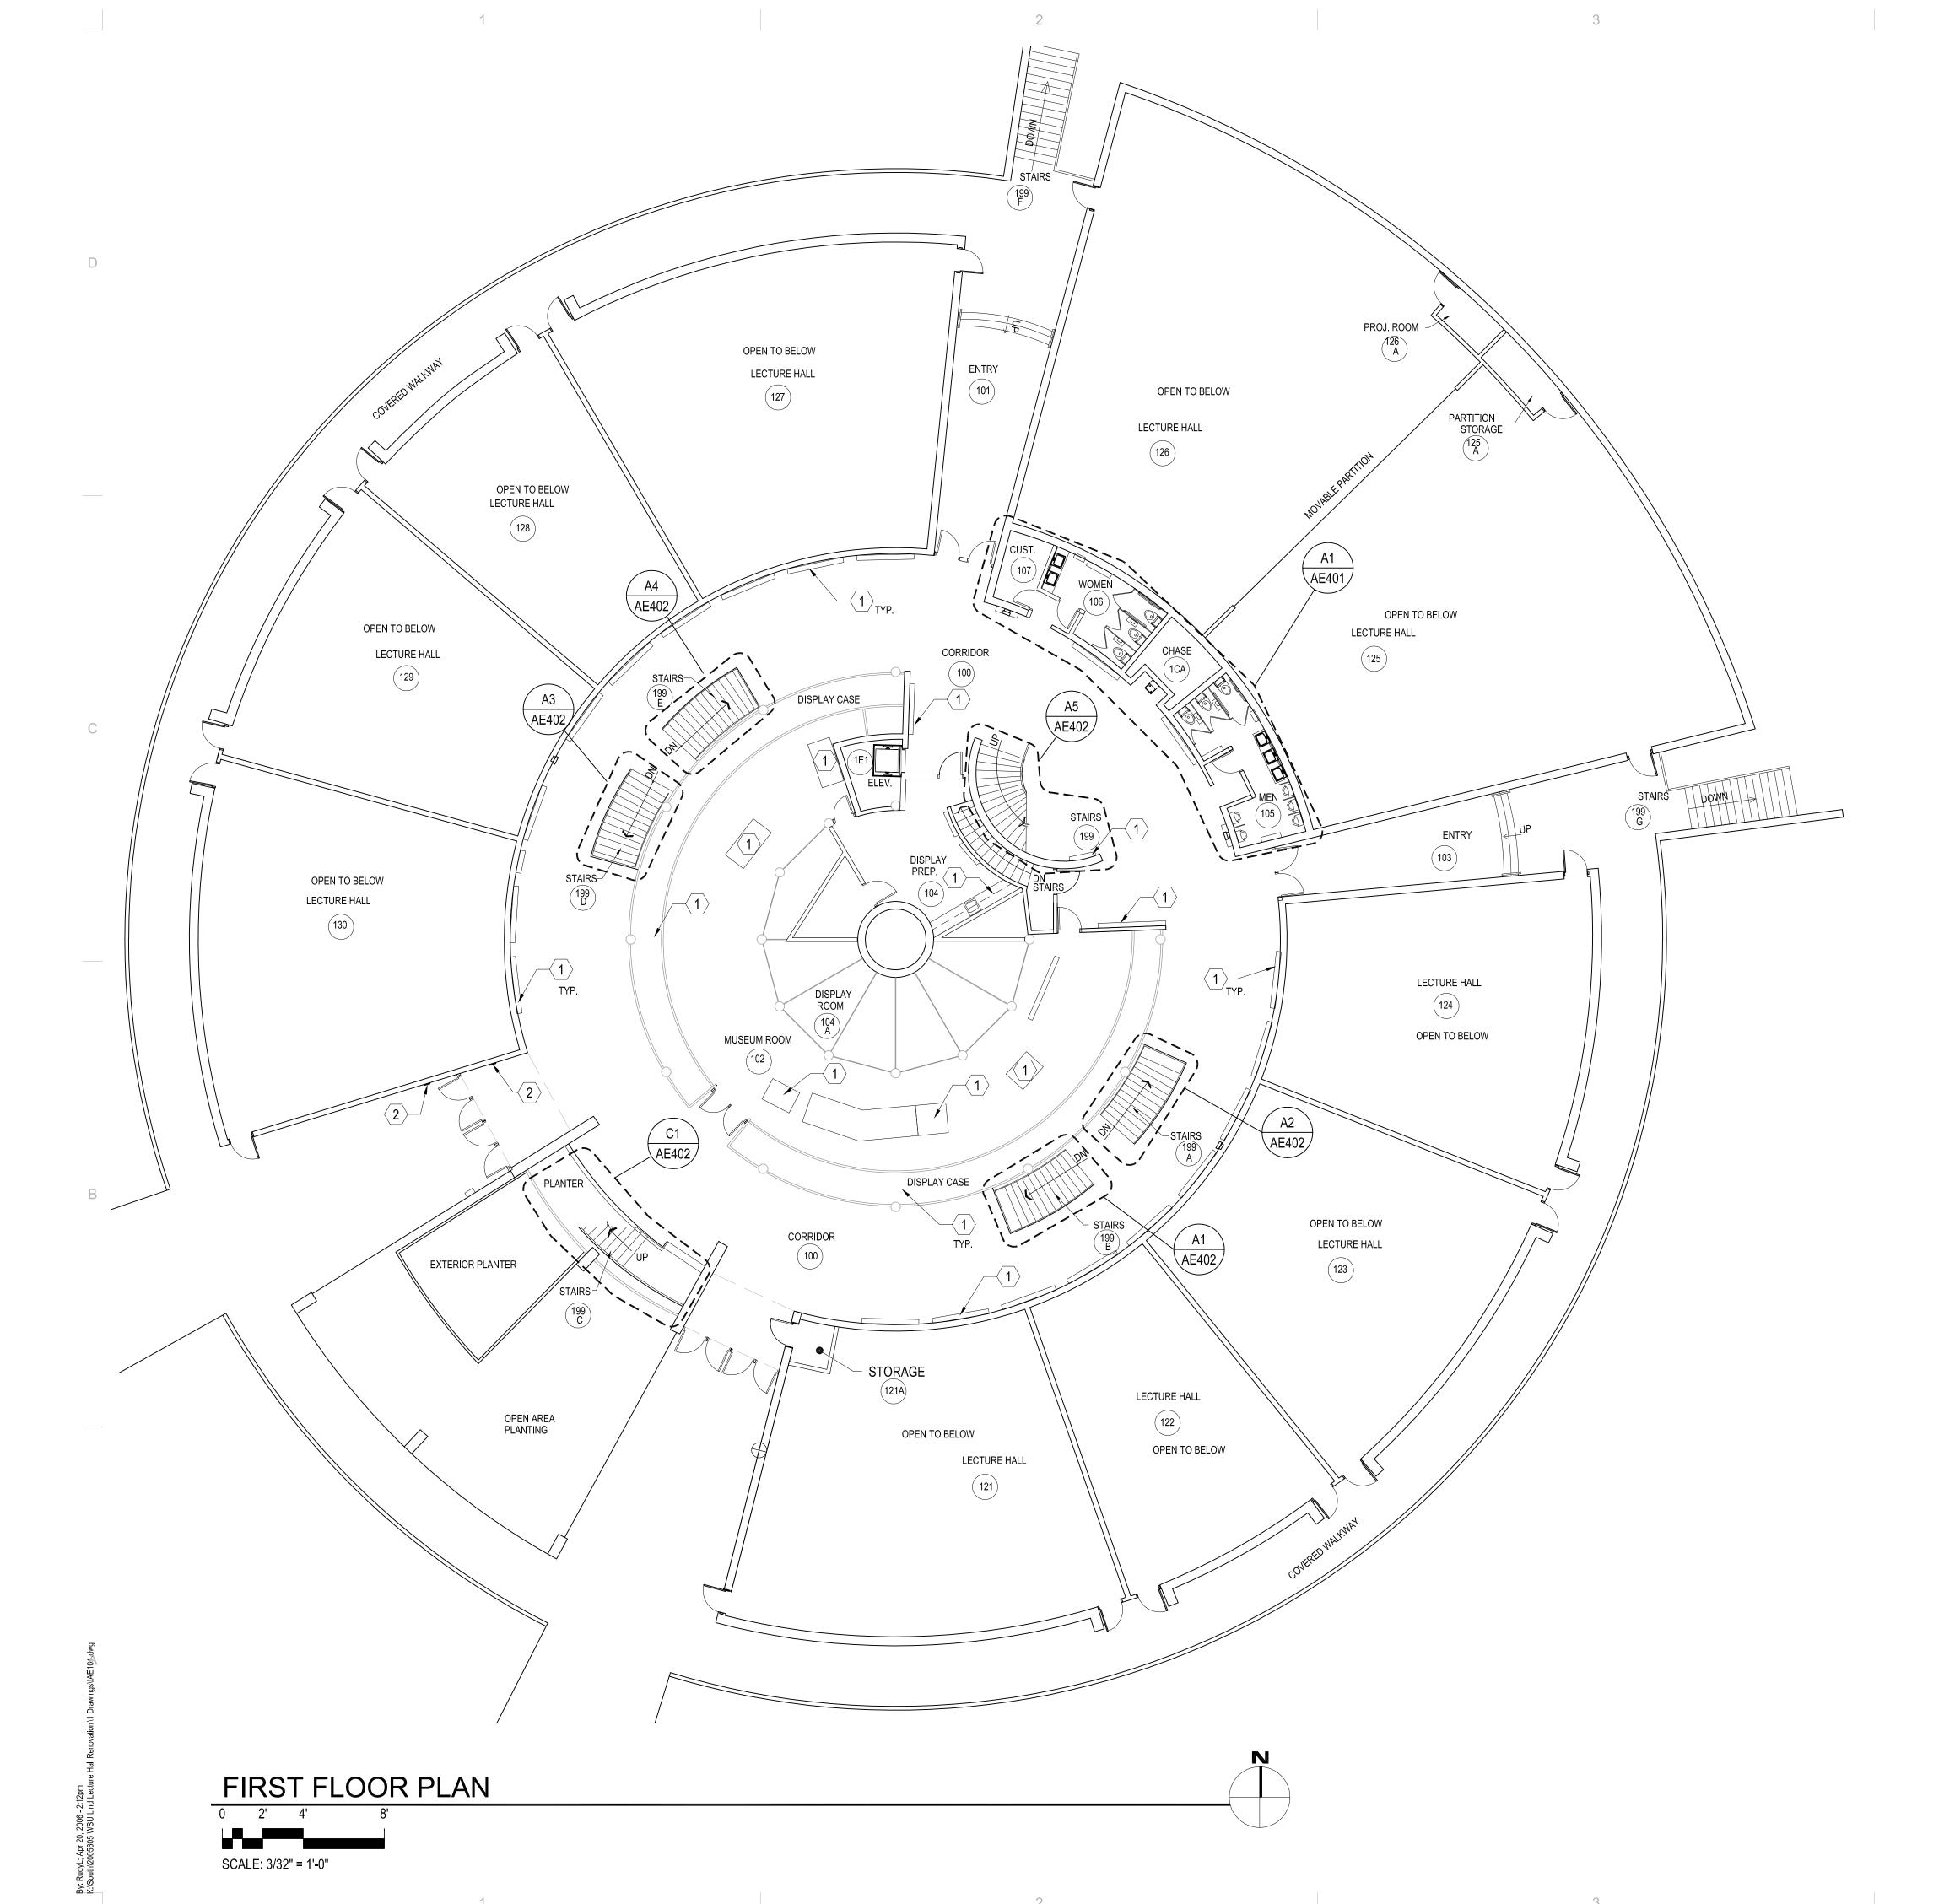


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ISSUEI	D:		
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GROUND FLOOR

CONSTRUCTION SET

SHEET NUMBE



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### **KEY NOTES**

REMOVE PROTECTIVE BARRIERS AFTER COMPLETION OF CONSTRUCTION.

2 AUTO DOOR OPERATOR ACTIVATOR

### LEGEND

EXISTING WALLS TO REMAIN

NEW PARTITIONS:
5/8" GYP.BD. EA. SIDE OF 3 5/8"
METAL STUDS @ 16" O.C., UP TO
DECK ABOVE, 1 HR. RATED, WITH
BATT. INSULATION UL DESIGN
U469 & U906.



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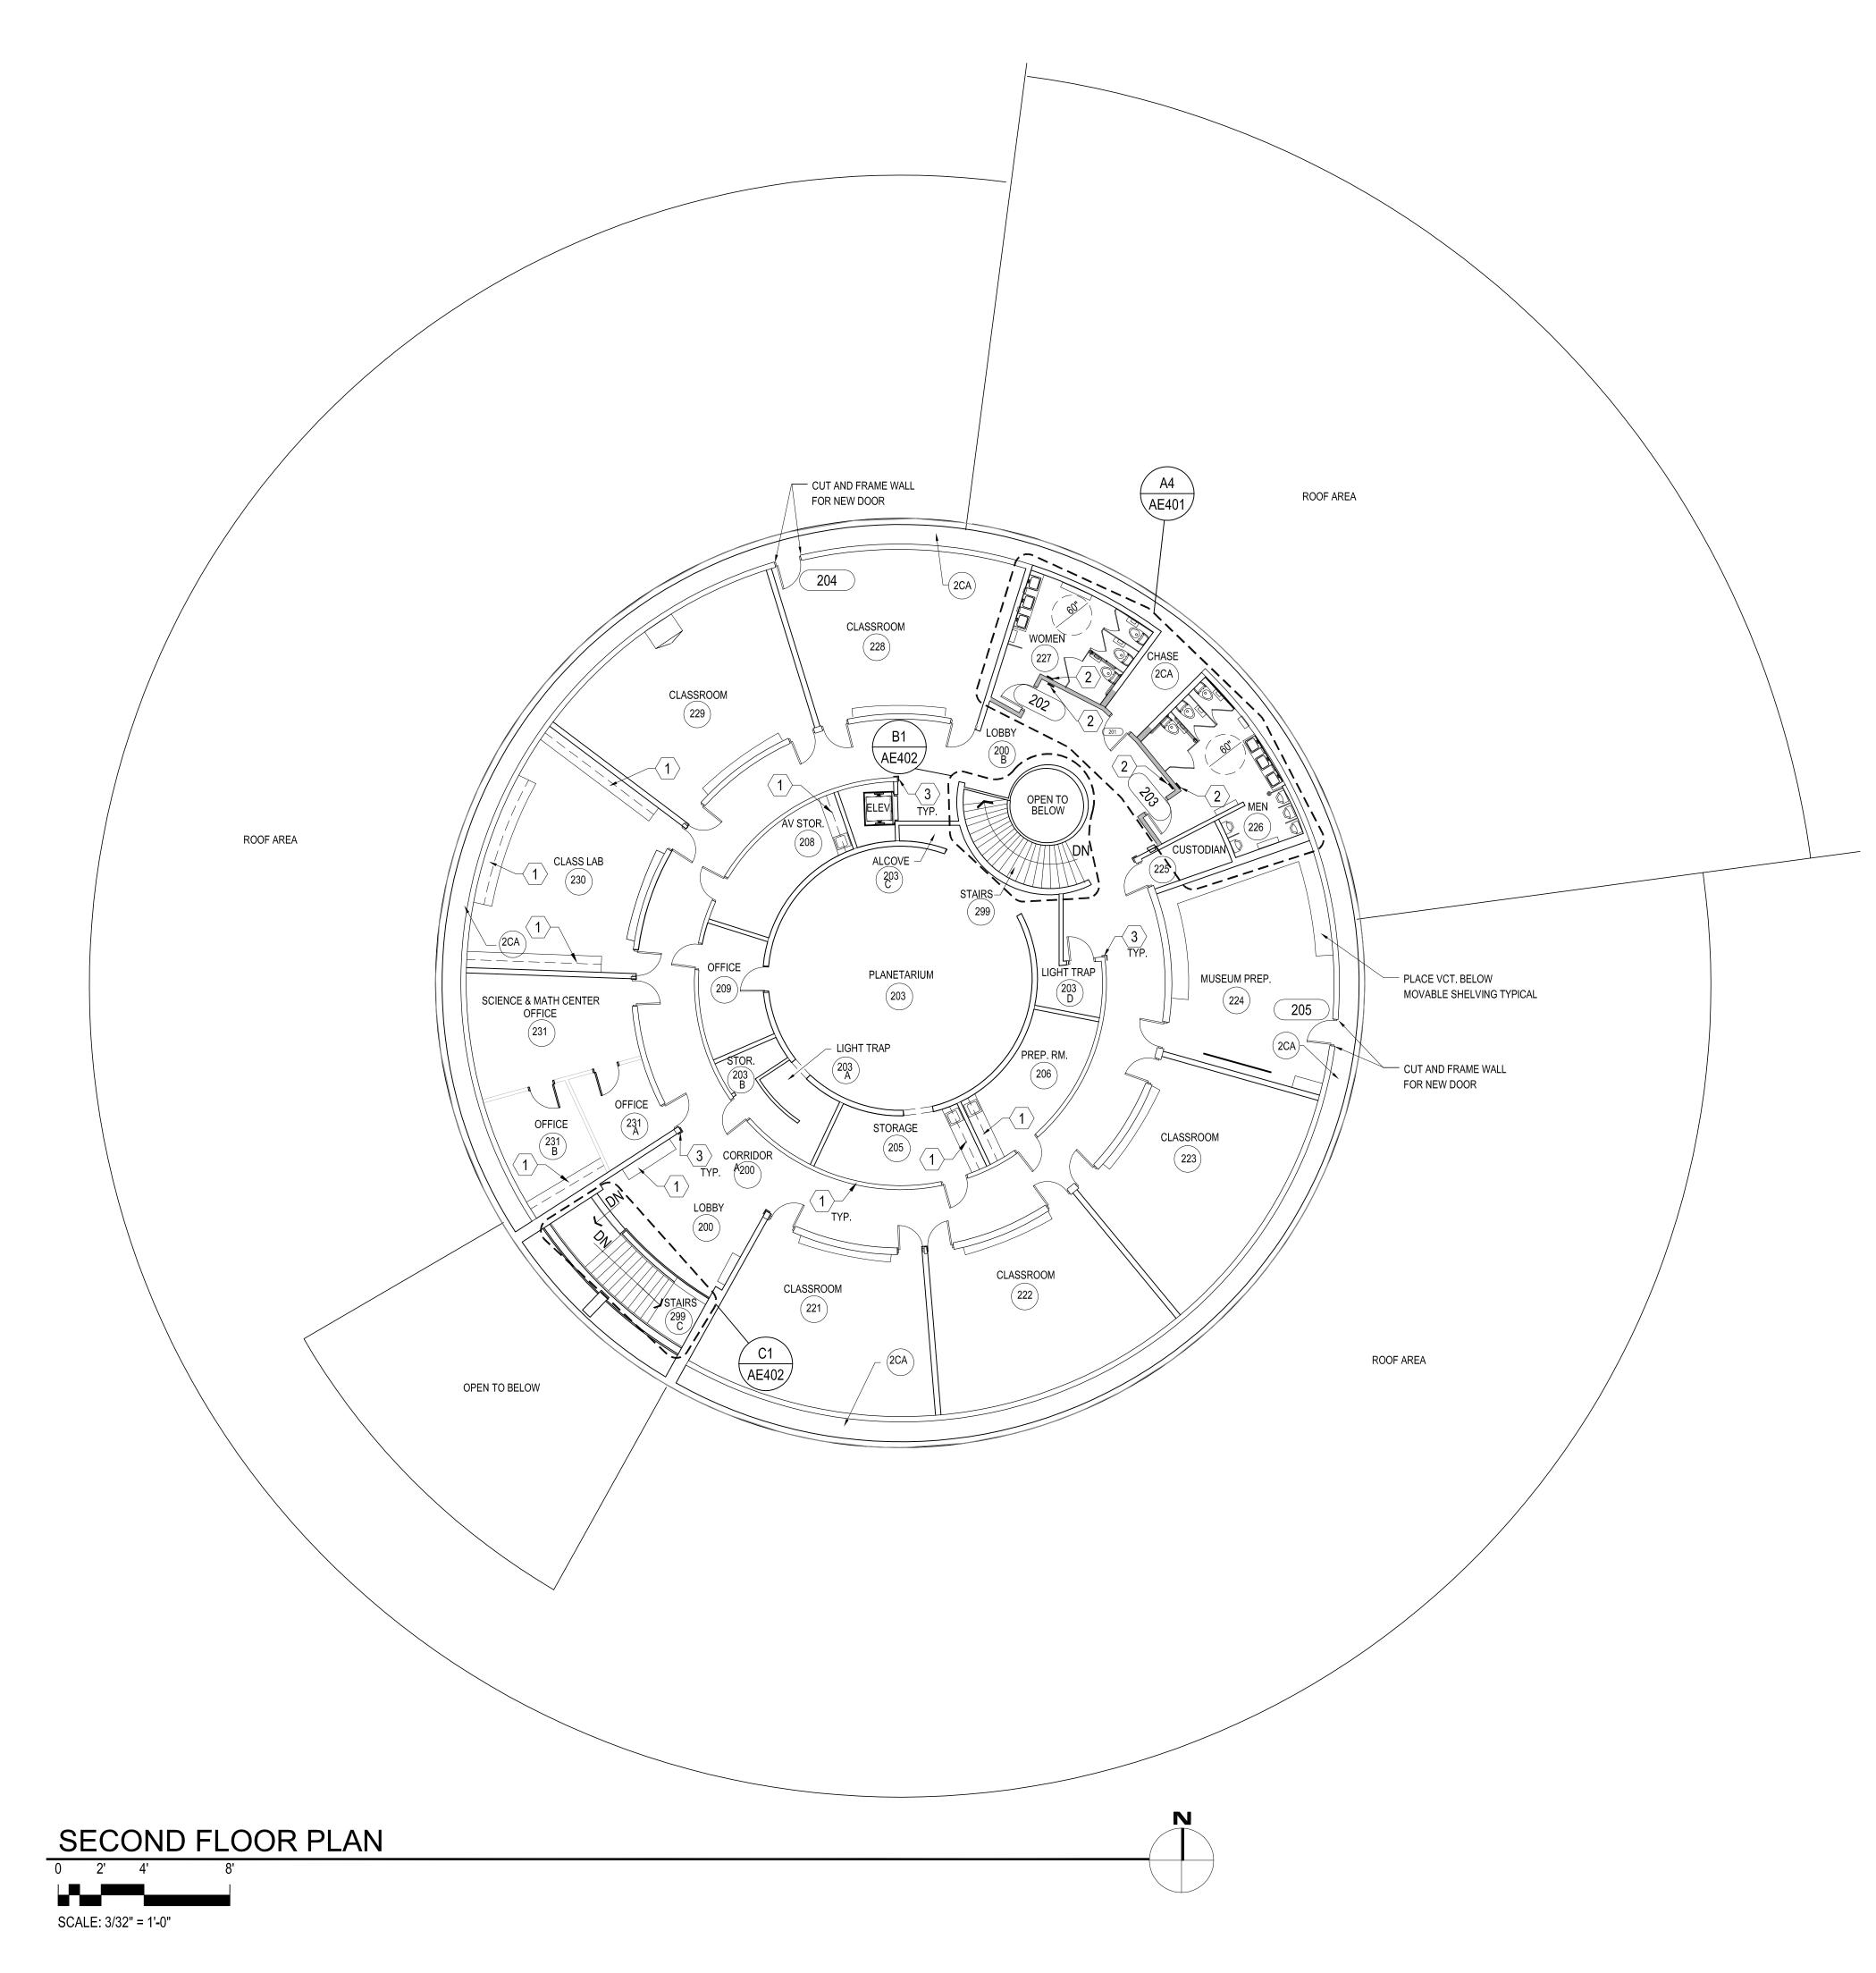
MICHAEL GAVIGLIO 4920978-0301

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NO.	DATE	DESCRIPTION
1	4.20.06	BID PACKAGE #2

FIRST FLOOR FLOOR PLAN

CONSTRUCTION SET

SHEET NUM



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### **KEY NOTES**

- 1 REMOVE PROTECTIVE BARRIERS AFTER COMPLETION OF CONSTRUCTION.
- AUTO DOOR OPERATOR ACTIVATOR (ALT. #4 @ 2ND FLOOR TOILETS)
- 3 CORNERGUARD

### **LEGEND**

EXISTING WALLS TO REMAIN

NEW PARTITIONS:
5/8" GYP.BD. EA. SIDE OF 3 5/8"
METAL STUDS @ 16" O.C., UP TO
DECK ABOVE, 1 HR. RATED, WITH
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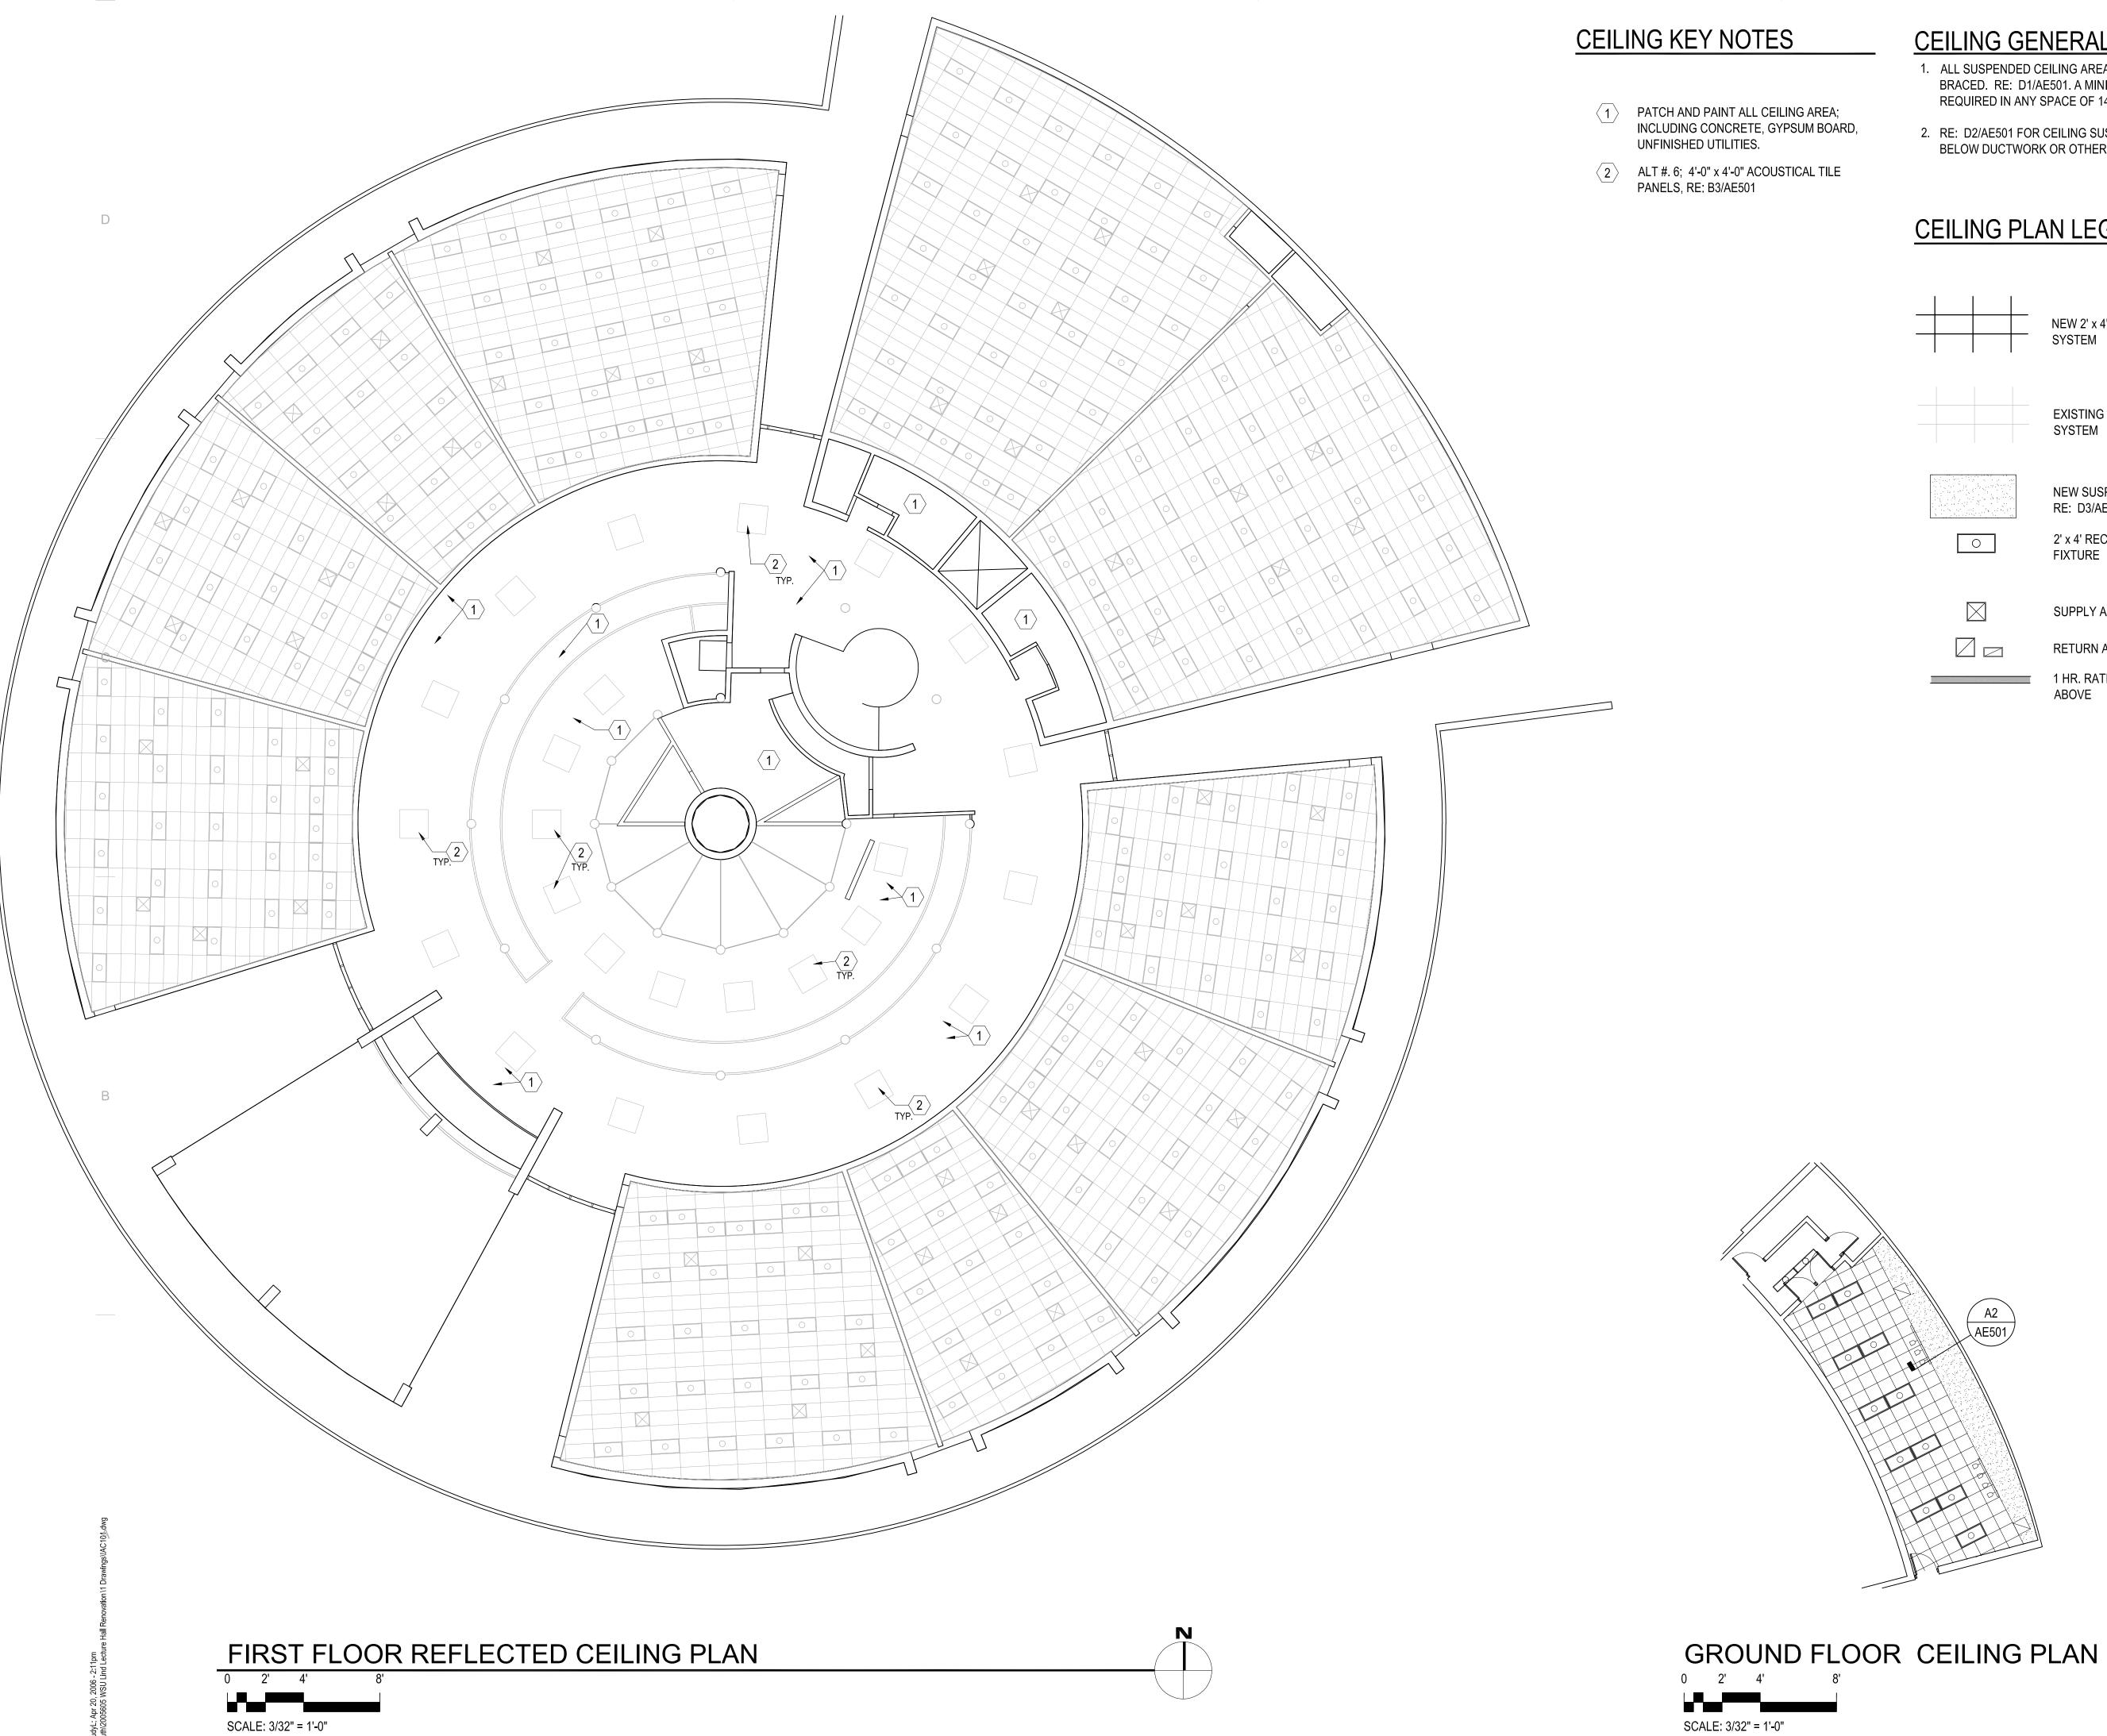
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SECOND FLOOR FLOOR PLAN

CONSTRUCTION SET

SHEET NUMBE



### CEILING KEY NOTES

- PATCH AND PAINT ALL CEILING AREA; INCLUDING CONCRETE, GYPSUM BOARD, UNFINISHED UTILITIES.
- ALT #. 6; 4'-0" x 4'-0" ACOUSTICAL TILE PANELS, RE: B3/AE501

### CEILING GENERAL NOTES

- 1. ALL SUSPENDED CEILING AREAS TO BE SEISMICALLY BRACED. RE: D1/AE501. A MINIMUM OF ONE BRACE REQUIRED IN ANY SPACE OF 144 S.F. OR LARGER.
  - 2. RE: D2/AE501 FOR CEILING SUSPENSION DETAIL BELOW DUCTWORK OR OTHER OBSTRUCTION.

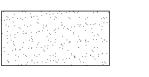


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### CEILING PLAN LEGEND



EXISTING 2' x 4' ACOUSTICAL CEILING TILE SYSTEM



NEW SUSP. GYP. BD. CEIING, 1 HR RATED, RE: D3/AE501



2' x 4' RECESSED FLUORESCENT LIGHT **FIXTURE** 



SUPPLY AIR DIFFUSER - SEE MECH.



RETURN AIR/EXHAUST GRILLE

1 HR. RATED WALL TO DECK ABOVE

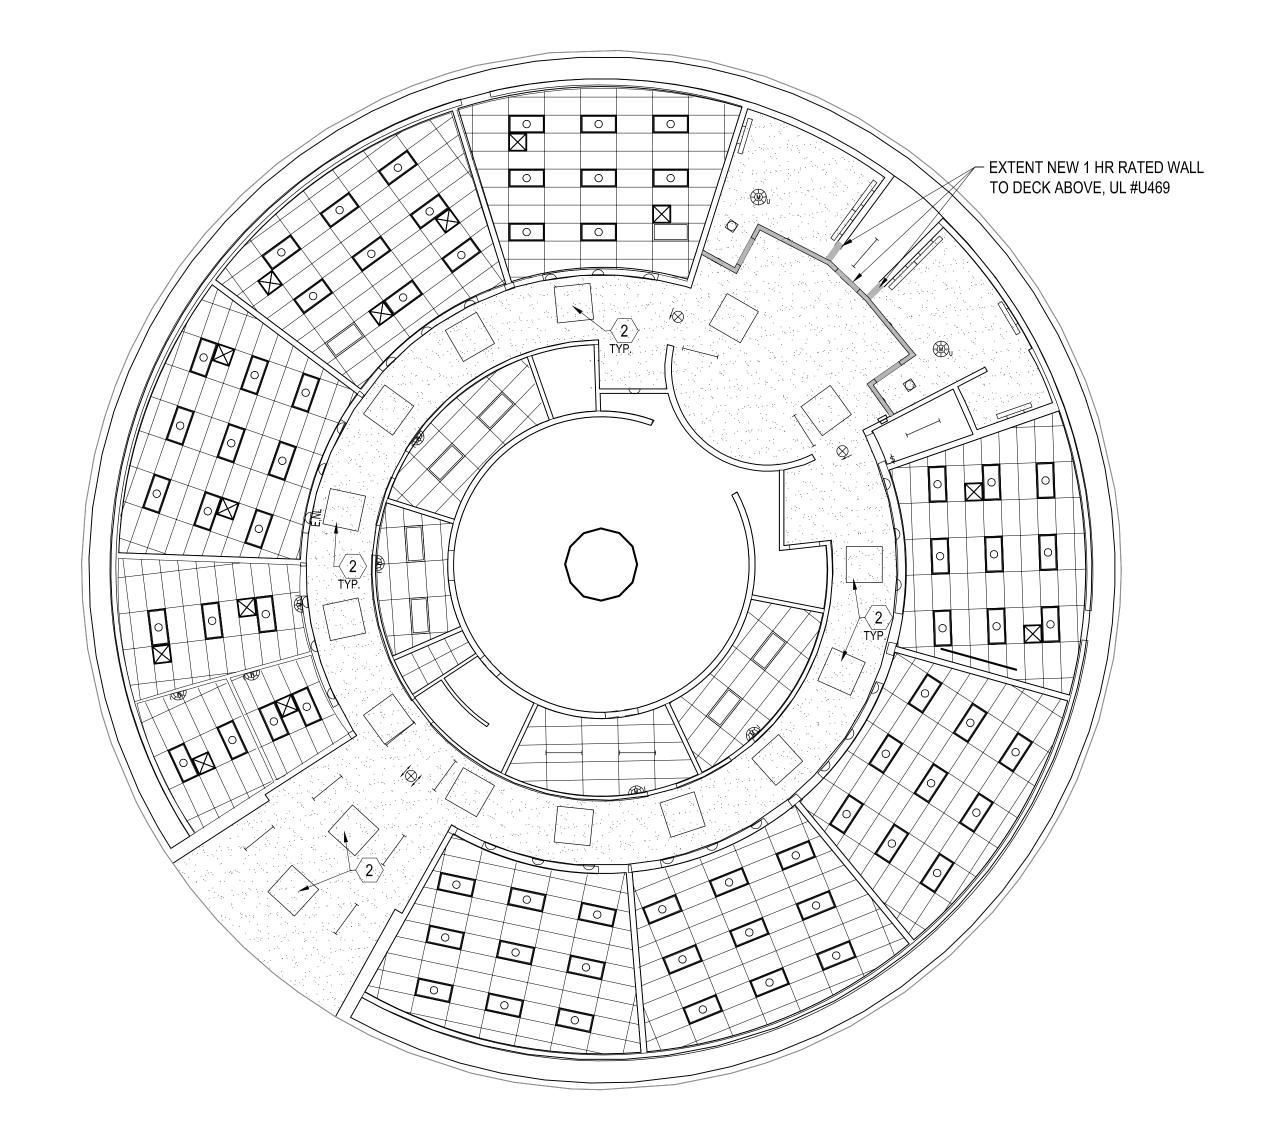


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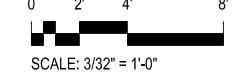
FIRST FLOOR CEILING PLAN

CONSTRUCTION SET

AC101



SECOND FLOOR REFLECTED CEILING PLAN



- UNFINISHED UTILITIES.

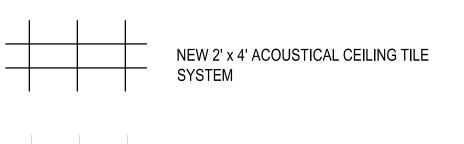
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- 2. RE: D2/AE501 FOR CEILING SUSPENSION DETAIL BELOW DUCTWORK OR OTHER OBSTRUCTION.

### CEILING PLAN LEGEND



SYSTEM

EXISTING 2' x 4' ACOUSTICAL CEILING TILE

NEW SUSP. GYP. BD. CEIING, 1 HR RATED,

2' x 4' RECESSED FLUORESCENT LIGHT **FIXTURE** 

RETURN AIR/EXHAUST GRILLE

RE: D3/AE501

1 HR. RATED WALL TO DECK

SUPPLY AIR DIFFUSER - SEE MECH.



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<b></b>	ND FLOOR IG PLAN

CONSTRUCTION SET

AC102

							DOO	R SCHE	EDULE						
Number		Door					F	rame			Flootrical	Fire Detine	Hardwara	Notos	Number
Number	Туре	Size	Thickness	Material	Type	Frame Depth	Material	Head Detail	Jamb Detail	Sill Detail	Electrical	Fire Rating	Hardware	Notes	Number
201	А	3'-0" x 7'-0"	1 3/4"	НМ	1	5 3/4"	НМ	C1/AE501	C2/AE501			60 MIN	Е		201
202	А	3'-0" x 7'-0"	1 3/4"	НМ	1	5 3/4"	НМ	C1/AE501	C2/AE501			20 MIN	D		202
203	Α	3'-0" x 7'-0"	1 3/4"	НМ	1	5 3/4"	НМ	C1/AE501	C2/AE501.			20 MIN	D		203
204	А	3'-0" x 7'-0"	1 3/4"	НМ	1	5 3/4"	НМ	C1/AE501	C2/AE501			60 MIN	E		204
205	Α	3'-0" x 7'-0"	1 3/4"	НМ	1	5 3/4"	НМ	C1/AE501	C2/AE501			60 MIN	Е		205

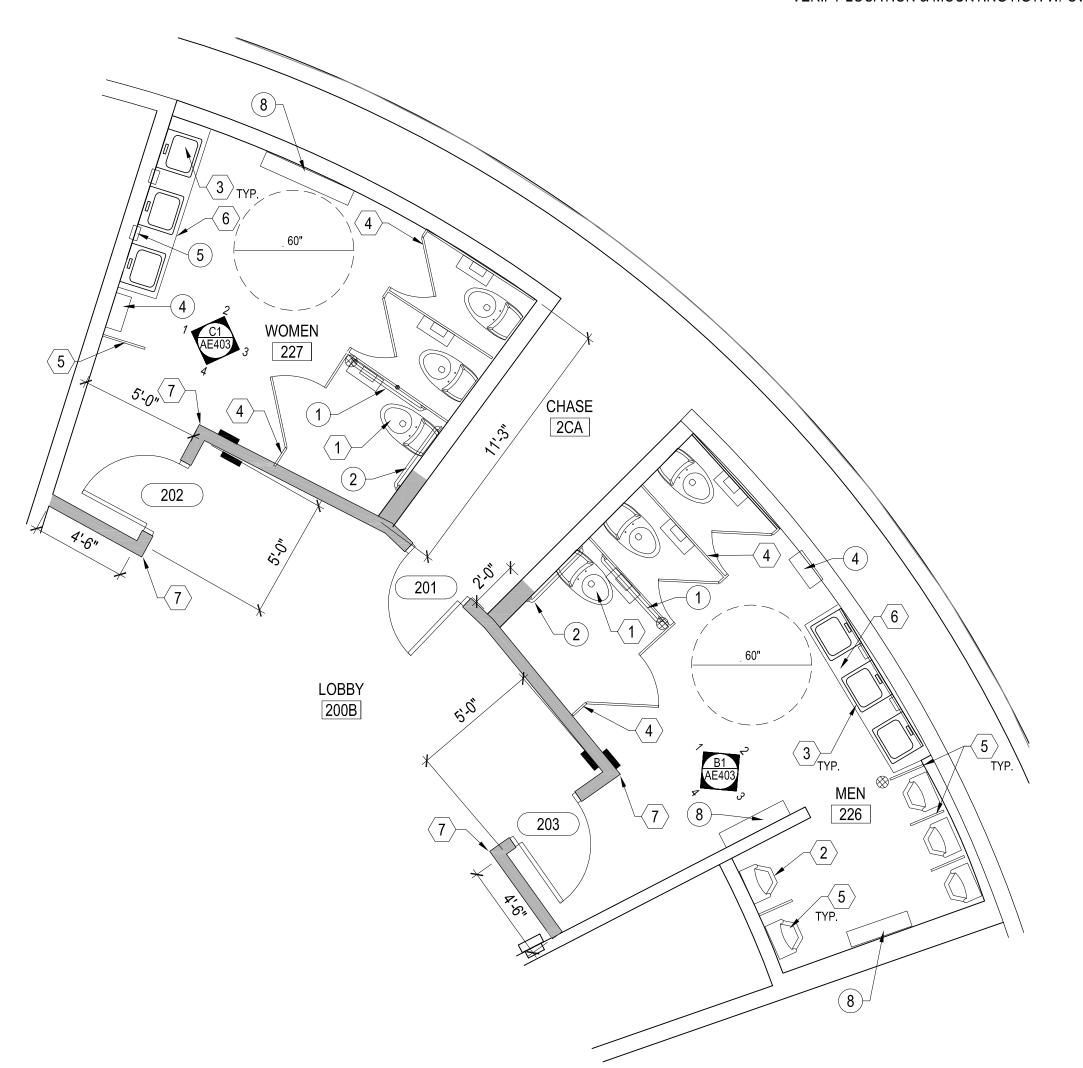
SEE SCHED	SEE SCHED 2"
SEE SCHED	SEE SCHED
DOOR TYPE A	FRAME TYPE 1

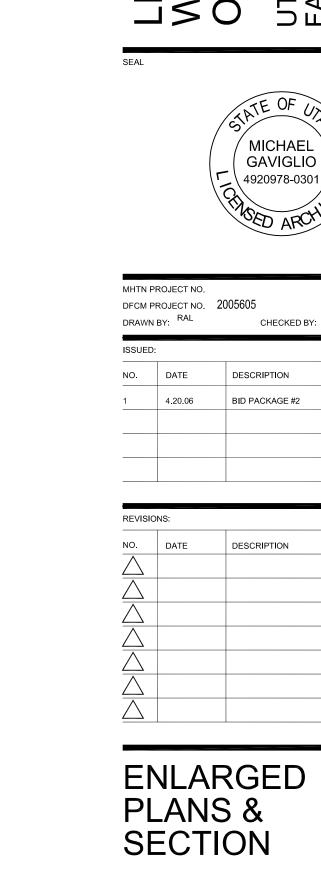
- 1 ACCESSIBLE WATER CLOSET
- $\left\langle \overline{2} \right\rangle$  ACCESSIBLE URINAL
- ACCESSIBLE LAVATORY W/ INSULATED PIPING
- FLOOR MOUNTED, OVERHEAD BRACED
- TOILET PARTITION (DOOR NOT SHOWN) 5 FLOOR MOUNTED URINAL PARTITION,
- 6 COUNTERTOP, RE: A2/AE403
- 7 CORNER GUARD

### ACCESSORY SCHEDULE

NO.	ITEM
1	GRAB BAR (42")
2	GRAB BAR (36")
3	TOILET TISSUE DISPENSER *
4	PAPER TOWEL DISPENSER, EXIST.
5	SOAP DISPENSER - WALL MOUNTED *
6	SANITARY NAPKIN DISPOSAL
7	MIRROR 30" X 40"
8	BACKPACK SHELF, RE: A1/501

<sup>\*</sup> PROVIDED BY OWNER, INSTALLED BY GENERAL CONTRACTOR, VERIFY LOCATION & MOUNTING HGT. W/ OWNER





MHTN ARCHITECTS, INC.

420 East South Temple Suite 100 Salt Lake City, Utah 84111 Telephone (801) 595-6700 Telefax (801) 595-6717 www.mhtn.com

FIRST FLOOR MEN 105 AND WOMEN 106 TOILET ROOMS

1/4" = 1'-0"

CHASE 1CA

CUP DISPENSER

REPAIR/REPLACE TILE AFTER ROUGH-IN FOR EWC.

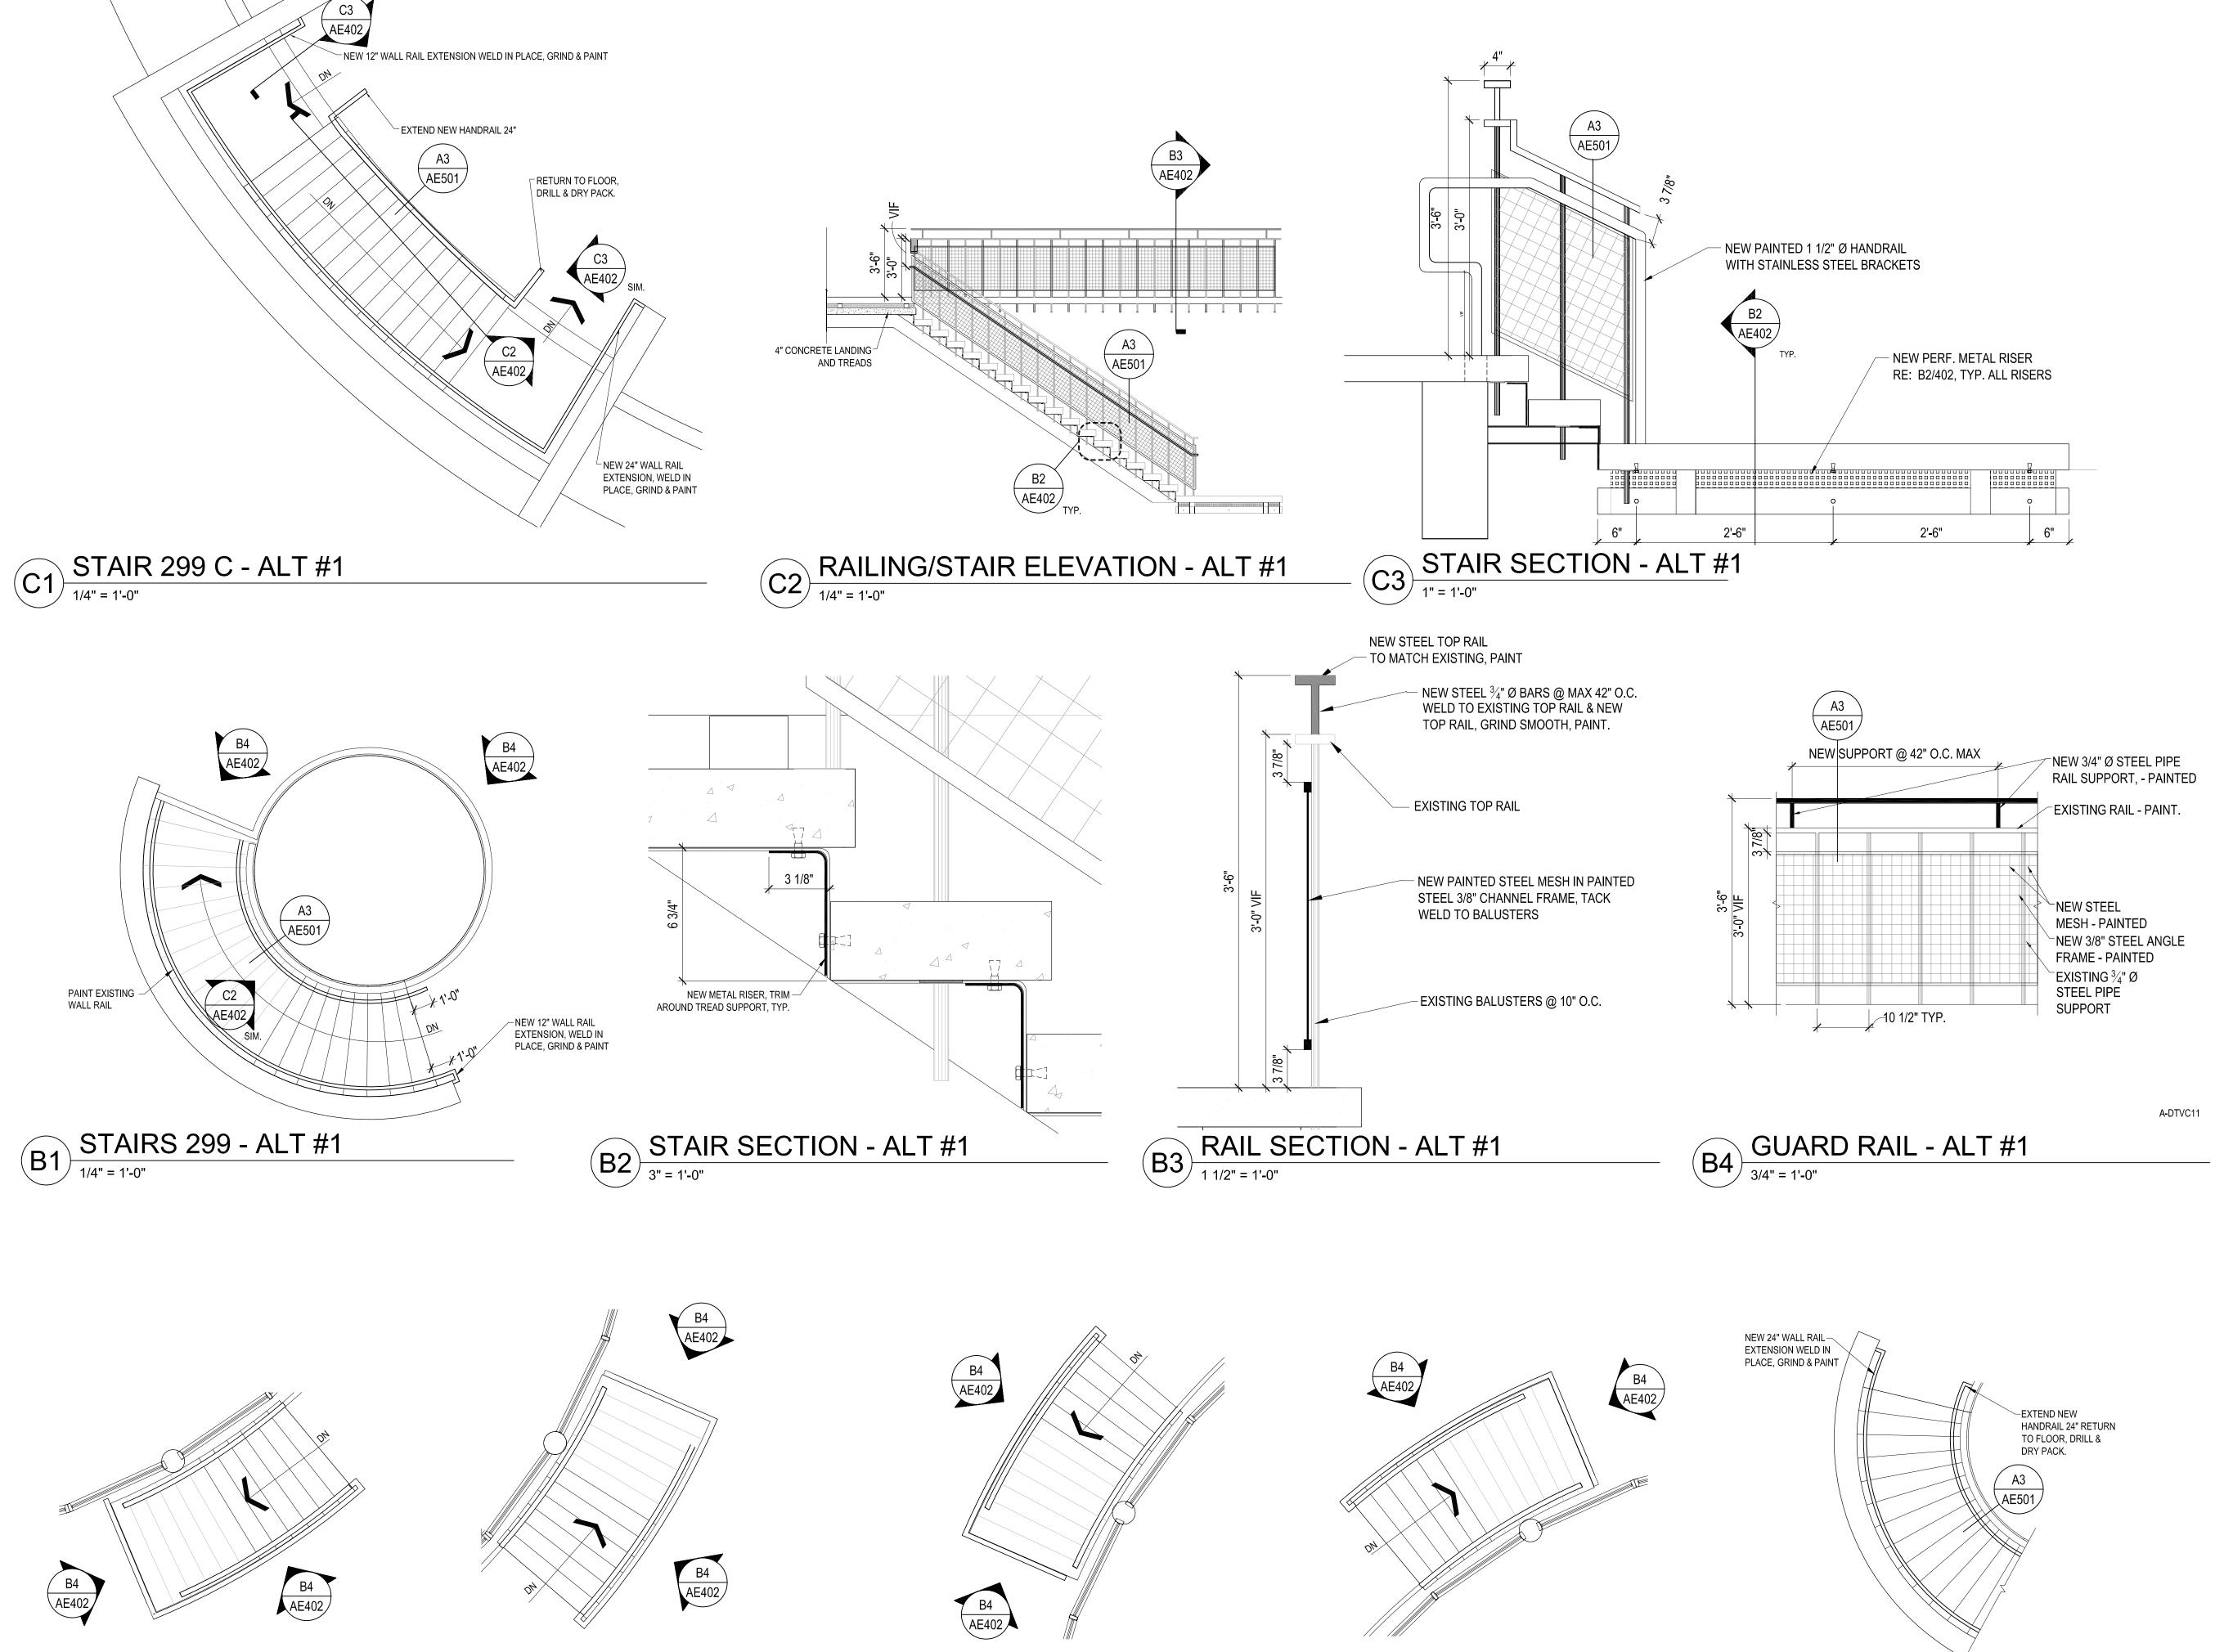
**ELEVATION** 

SECOND FLOOR MEN 226 AND WOMEN 227 TOILET ROOMS

1/4" = 1'-0"

AE401

CONSTRUCTION SET



A1 STAIRS 199 B - ALT #1

A2 STAIRS 199 A - ALT #1

TYP NOTE: PAINT THE EXISTING COMPLIANT WALL RAILINGS.



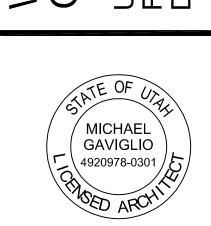


A5 STAIRS 199 - ALT #1



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SEN CAMPUS OGDEN, UTAP



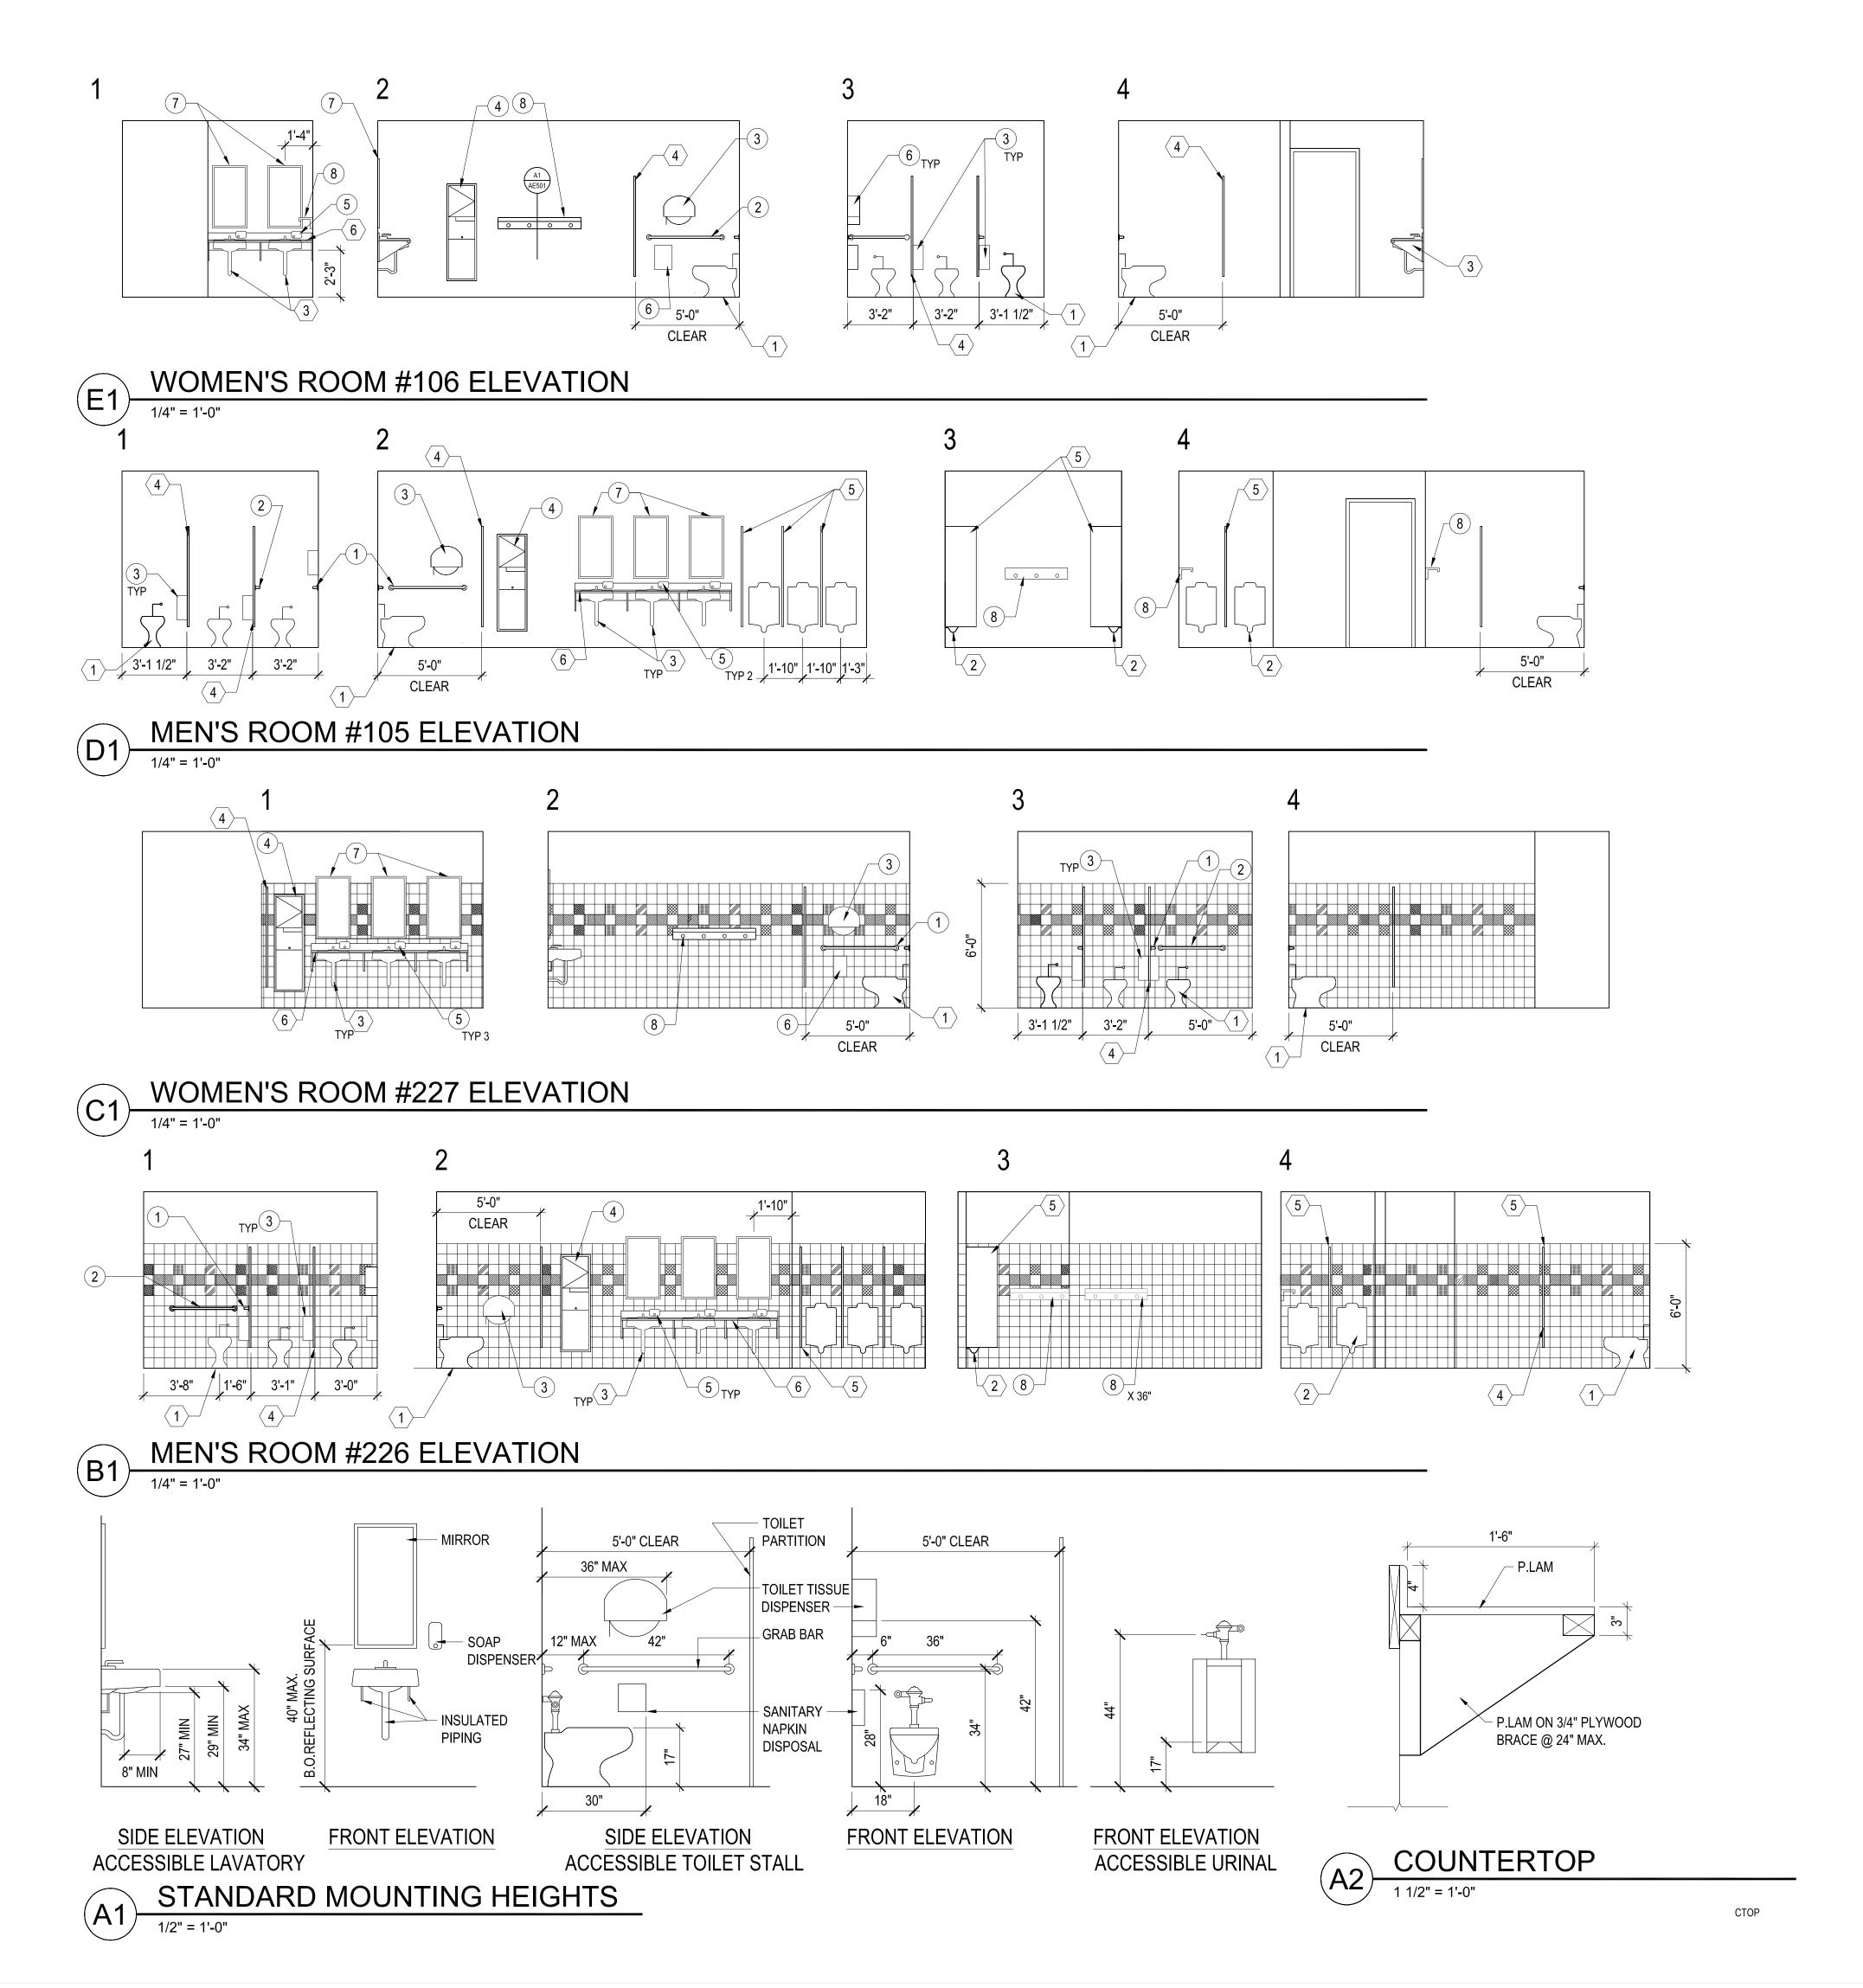
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ISSUEI	D:			
NO.	DATE		DESCRIPTION	
1	4.20.06		BID PACKAGE #2	

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NO.	DATE	DESCRIPTION	
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ENLARGED STAIR PLAN & DETAILS - ALT #1

CONSTRUCTION SET

SHEET NUMBER



- 1 ACCESSIBLE WATER CLOSET
- ACCESSIBLE URINAL
- ACCESSIBLE LAVATORY W/ INSULATED PIPING
- FLOOR MOUNTED, OVERHEAD BRACED TOILET PARTITION (DOOR NOT SHOWN)
- 5 FLOOR MOUNTED URINAL PARTITION,
- (6) COUNTERTOP, RE: A2/AE403

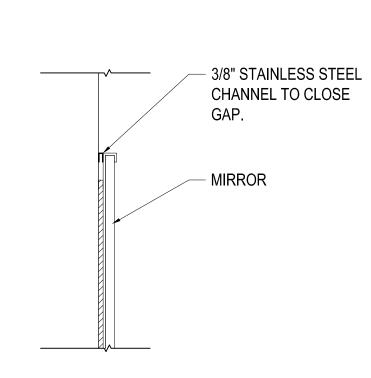
### **GENERAL NOTES**

- 1. PROVIDE STUD WALL BACKING FOR ALL SURFACE MOUNTED ACCESSORIES.
- 2. CEMENTITIOUS BACKER BOARD (WHERE TILE OCCURS) @ STUD WALLS 3. ALL TILE IN RESTROOMS TO BE 6'-0" HIGH INCLUDING
- BEHIND MIRRORS, RE: A3/AE403.
- 4. PATCH ANY DAMAGED EXISTING TILE WITH MATCHING TILE.
- 5. RE: B1/AE501 FOR WALL TILE PATTERN.
- 6. RE: B2/AE501 FOR FLOOR TILE PATTERN.

### ACCESSORY SCHEDULE

NO.	ITEM
1	GRAB BAR (42")
2	GRAB BAR (36")
3	TOILET TISSUE DISPENSER *
4	PAPER TOWEL DISPENSER, EXIST.
5	SOAP DISPENSER - WALL MOUNTED *
6	SANITARY NAPKIN DISPOSAL
7	MIRROR 30" X 40"
8	BACKPACK SHELF, RE: A1/501

★ PROVIDED BY OWNER, INSTALLED BY GENERAL CONTRACTOR, VERIFY LOCATION & MOUNTING HGT. W/ OWNER







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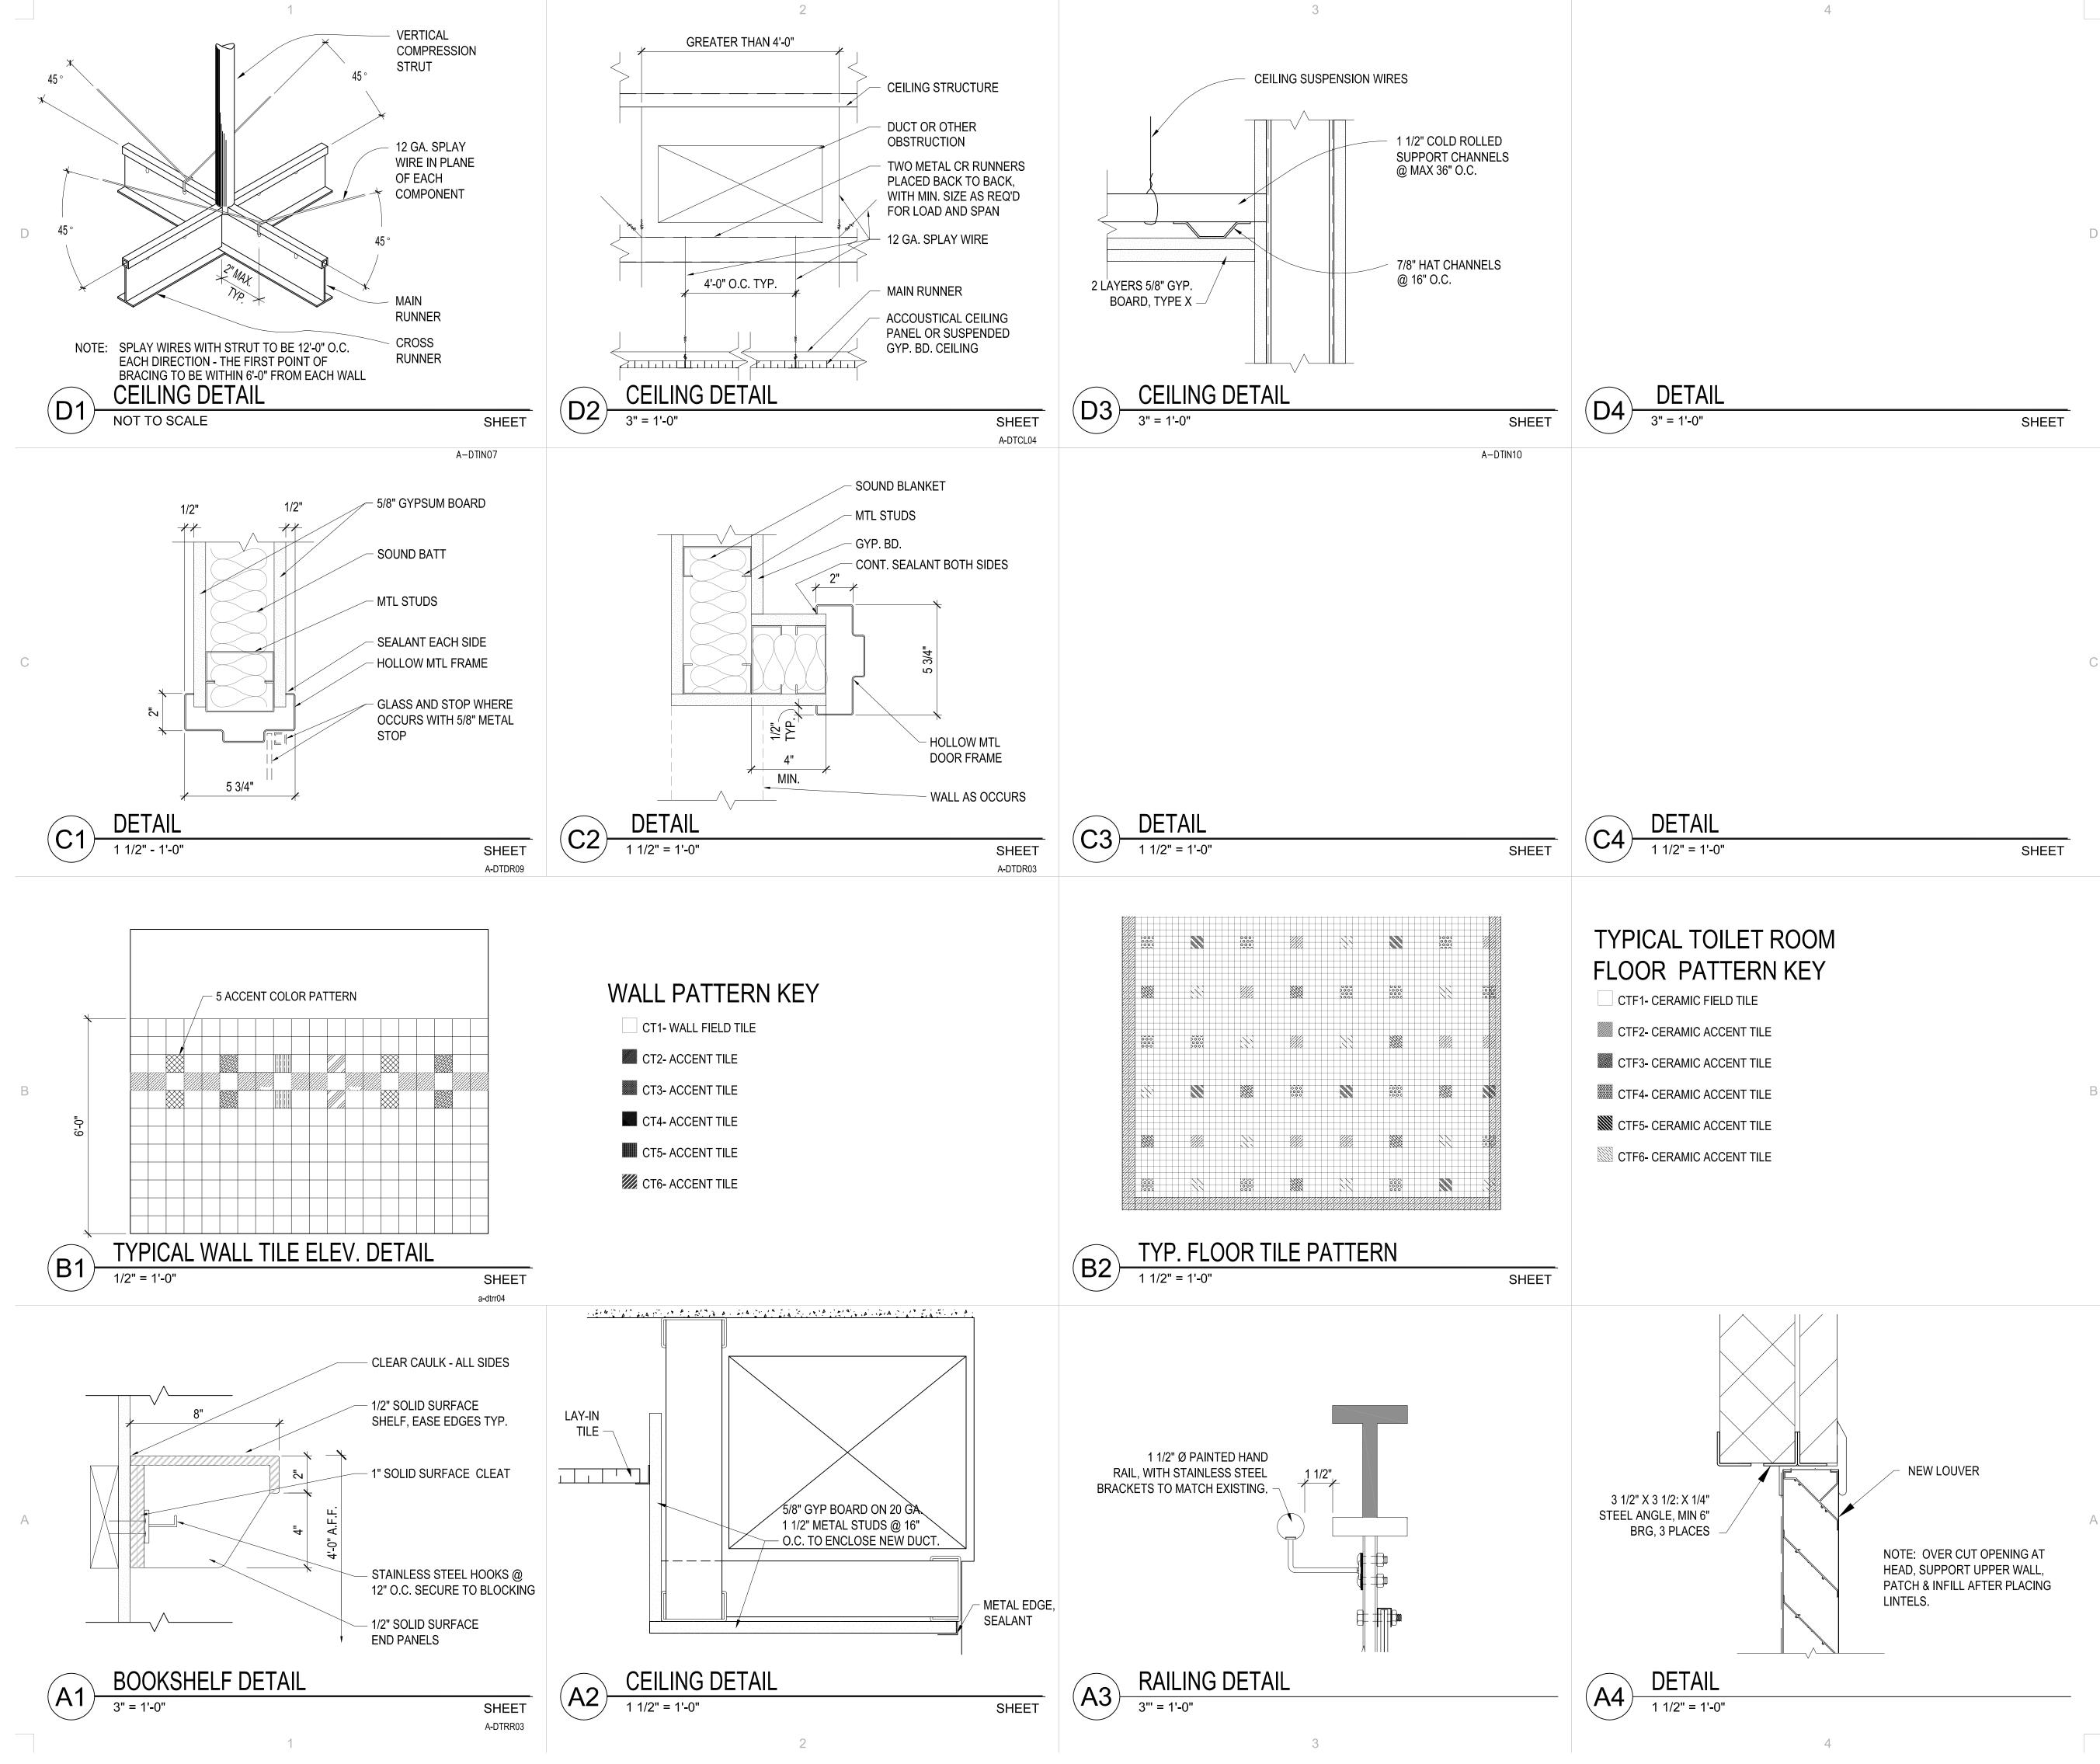
MICHAEL GAVIGLIO 4920978-0301

	PROJECT NO. N BY: RAL	CHECKED BY: MG
ISSUE	D:	
NO.	DATE	DESCRIPTION
1	4.20.06	BID PACKAGE #2

REVISIONS:

RESTROOM ELEVATIONS

**CONSTRUCTION SET** 



By: RudyL; Apr 20, 2006 - 2:19pm K-South/20105605 WSUL Ind Lecture Hall Renovation \1 Drawings\\AE50 Salt Lake City, Utah 84111 Telephone (801) 595-6700 Telefax (801) 595-6717 www.mhtn.com

MHTN ARCHITECTS, INC.

420 East South Temple

Suite 100

IND LECTURE HALL REMODEL
VEBER STATE UNIVERSITY
GDEN CAMPUS OGDEN, UTAH

MICHAEL GAVIGLIO 4920978-0301

MHTN PROJECT NO.

2005605

DRAWN BY: RAL CHECKED BY: MG

ISSUED:

NO. DATE DESCRIPTION

REVISIONS:

NO. DATE DESCRIPTION

A DATE DESCRIPTION

A DATE DESCRIPTION

DETAILS

CONSTRUCTION SET

			FINIS	H SCHEDULE					
RM.	# ROOM NAME	FLOOR	BASE	NORTH WALL	EAST WALL	SOUTH WALL	WEST WALL	CEILING	RM.# REMARKS
		T CARPET MOSAIC TILE VCT EXISTING A STANDED TO THE EXISTING TH	T CERAMIC TILE EXISTING  NONE	2 CERAMIC TILE EXISTING	De Paint GYPSUM BOARD De ACOUSTICAL TILE De EXPOSED - PAINT De EXISTING De EXPOSED - NO FINISH De EXPOSED - NO FINISH De ALTERNATE: ACOUSTICAL SPRAY				
LEVEL									
	CADAVER LAB	4	3	1	1	1	1	4	020
GROUND									
100 101 102	ENTRY MUSEUM ROOM	3 4 3	1 3	1 3 1	1 3	1 3	1 3	3 6 6 3 4 5 6 6 6 6 6 6 6 6 6 6 6 6 6 6 6 6 6 6	100 PATCH AND PAINT CEILING 101 102
104 105	DISPLAY PREP.  A DISPLAY ROOM  MEN'S RESTROOM	4 4 4 4	3 3 1 3 1	3 3 1 1 1 1 1 1 1 1 1 1 1 1 1 1 1 1 1 1	3 3 1	3 3 1	3 6 6 1 1 1 1 1 1 1 1 1 1 1 1 1 1 1 1 1	103 104 104A 105
106 107 121 122 123	CUSTODIAN  LECTURE HALL  LECTURE HALL	4 4 4 4 4 4 4 4 4 4 4 4 4 4 4 4 4 4 4 4	3 3 3 3 3	3 3 3 3	3 3 3 3	3 3 3	3 3 3 3	4 4 4 4 4 4 4 4 4 4 4 4 4 4 4 4 4 4 4 4	106 107 121 122 123
124 125	LECTURE HALL LECTURE HALL A STORAGE	4 4 4 4 4 4 4 4 4 4 4 4 4 4 4 4 4 4 4 4	3 3 4 4 4 4 4 4 4 4 4 4 4 4 4 4 4 4 4 4 4 4	124 125 125A 126
125 126 127 128 129 130 199 199	LECTURE HALL LECTURE HALL LECTURE HALL	4 4 4 4 4 4 4 4 4 4 4 4 4 4 4 4 4 4 4	3 3 3 3 3	3 3 3 3 3	3 3 3 3 3	3 3 3 3 3	3 3 3 3 3	4	126A 127 128 129
199	STAIRS A STAIRS B STAIRS	4 4 4 4 4 4 4 4 4 4 4 4 4 4 4 4 4 4 4 4	3 4 3 3 3 4	3 3 1 1	3 1 1 1 1 1 1 1 1 1 1 1 1 1 1 1 1 1 1 1	3 1 1 1 1 1 1 1 1 1 1 1 1 1 1 1 1 1 1 1	3 1 1 1	4       1       6       1       6       1       6	130 199 199A 199B
199	C STAIRS D STAIRS E STAIRS	4 4 4	3 3	1 1 6 1 1 6 1 1 1 6 1 1 1 1 1 1 1 1 1 1 1	199C 199D 199E
	LOBBY A CORRIDOR	3 3	1 1	1 1	1 1	1 1	1 1	1 6 1	200 200A
200 203 203 203	B LOBBY PLANETARIUM A LIGHT TRAP B STORAGE	3 4 4 4 4 4 4 4 4 4 4 4 4 4 4 4 4 4 4 4	1 3 3 3 3 3 3 3 3 3 3 3 3 3 3 3 3 3 3 3	1 3 3 3 3 3 3 3 3 3 3 3 3 3 3 3 3 3 3 3	1 3 3 3 3 3 3 3 3 3 3 3 3 3 3 3 3 3 3 3	1 3 3 3 3 3 3 3 3 3 3 3 3 3 3 3 3 3 3 3	1 3 3 3 3 3 3 3 3 3 3 3 3 3 3 3 3 3 3 3	1 6 4 4 4 4 4 4 4 4 4 4 4 4 4 4 4 4 4 4	200B 203 203A 203B
203 203 205 205 206	C ALCOVE D LIGHT TRAP STORAGE PREP. ROOM	4 4 4 4 4 4 4 4 4 4 4 4 4 4 4 4 4 4 4 4	3 3 3 3	3 3 1 1 1 1 1 1 1 1 1 1 1 1 1 1 1 1 1 1	3 3 1 1	3 3 1 1	3 3 1 1	4 4 4 4 4 4 4 4 4 4 4 4 4 4 4 4 4 4 4 4	203C 203D 205 206
203 203 205 206 208 209 221 222 223 224 225 226	AV STORAGE OFFICE CLASSROOM CLASSROOM CLASSROOM	1 4 4 4 4 4 4 4 4 4 4 4 4 4 4 4 4 4 4 4	1 1 208 209 221 222 223
224 225 226 227	MUSEUM PREP. CUSTODIAN MEN'S RESTROOM WOMEN'S RESTROOM	3 4 2 2 2 2 2 2 2 2 2 2 2 2 2 2 2 2 2 2	1 3 2 2 2 2 2 2 2 2 2 2 2 2 2 2 2 2 2 2	1 3 2 2 2 2 2 2 2 2 2 2 2 2 2 2 2 2 2 2	1 2 2 2	1 2 2 2	1 2 2 2	1 1	224 225 226 227
228 229 230 231	CLASSROOM CLASS LAB SCIENCE/MATH CENTER OFC	4       4       4       4       1	1 2 2 2 2 2 2 2 2 2 2 2 2 2 2 2 2 2 2 2	228       229       230       231
	A OFFICE B OFFICE C STAIRS	1 4 4	1 4	1 3 3	1 1 1 1 1 1 1 1 1 1 1 1 1 1 1 1 1 1 1 1	1 1 1 1 1 1 1 1 1 1 1 1 1 1 1 1 1 1 1 1	1 1 1 1 1 1 1 1 1 1 1 1 1 1 1 1 1 1 1 1	1 6	231A 231B 299C



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	ATE OF U	7
	MICHAEL GAVIGLIO 4920978-030	
(H)	ISED ARC	

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ISSUED	):	
NO.	DATE	DESCRIPTION

DFCM PROJECT NO. 2005605

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FINISH PLAN

CONSTRUCTION SET

### DRAWINGS INDEX

CUEET			REVI	SIONS	
SHEET NUMBER	SHEET TITLE	- -	- -	- -	<u>-</u>
MH001	LEGEND AND ABBREVIATIONS				
MH200	GROUND FLOOR MECHANICAL REMODEL PLAN				
MH201	FIRST FLOOR MECHANICAL REMODEL PLAN				
MH202	SECOND FLOOR MECHANICAL REMODEL PLAN				
MH501	MECHANICAL DETAILS				
MH601	MECHANICAL SCHEDULES				
PL200	GROUND FLOOR PLUMBING REMODEL PLAN				
PL201	FIRST FLOOR PLUMBING REMODEL PLAN				
PL202	SECOND FLOOR PLUMBING REMODEL PLAN				
PL501	PLUMBING DETAILS				
PL601	PLUMBING SCHEDULES				
-	-				

### **ABBREVIATIONS**

Ø	ROUND OR DIAMETER	MBH	THOUSAND BRITISH THERMAL UNITS/HOUR
AD	ACCESS DOOR	MECH	MECHANICAL
AF	AIRFOIL	MIN	MINIMUM
AFF	ABOVE FINISHED FLOOR	NC	NOISE CRITERIA OR NORMALLY CLOSED
ALT	ALTERNATE	NIC	NOT IN CONTRACT
BI	BACKWARD INCLINED	NO.	NUMBER
BOD	BOTTOM OF DUCT	NOM	NOMINAL
BOP	BOTTOM OF PIPE	NTS	NOT TO SCALE
BTU/H	BRITISH THERMAL UNITS PER HOUR	OA	OUTSIDE AIR
CAP.	CAPACITY	OBD	OPPOSED BLADE DAMPER
CFM	CUBIC FEET PER MINUTE	OD	OVERFLOW DRAIN
CV	CONSTANT VOLUME	OFCI	OWNER FURNISHED, CONTRACTOR INSTALLED
DB	DRY BULB	OFOI	OWNER FURNISHED, OWNER INSTALLED
DIA	DIAMETER	PD	PRESSURE DROP
DSN	DOWN SPOUT NOZZLE	POC	POINT OF CONNECTION
DW	DISHWASHER	PRV	PRESSURE REDUCING VALVE
(E)	EXISTING  ENTERING AID TEMPERATURE	PSI	POUNDS PER SQUARE INCH
EAT	ENTERING AIR TEMPERATURE	PSIG	POUNDS PER SQUARE INCH GAUGE
EFF	EFFICIENCY	RA	RETURN AIR
ELEV	ELEVATION	RAD	RADIUS
ENCL	ENCLOSURE	RD	ROOF DRAIN
ESP	EXTERNAL STATIC PRESSURE	RPBP	REDUCED PRESSURE BACKFLOW PREVENTER
ET	EXPANSION TANK	SA	SUPPLY AIR
EWC	ELECTRIC WATER COOLER	SEN	SENSIBLE
EWT	ENTERING WATER TEMPERATURE	SIM	SIMILAR
FCO	FLOOR CLEANOUT	SL	SEA LEVEL
FD	FLOOR DRAIN	SP	STATIC PRESSURE
FPM	FEET PER MINUTE	SQ FT	SQUARE FEET
FS	FLOOR SINK	SS	SERVICE SINK OR STAINLESS STEEL
FT	FEET SAGE VELOCITY	TOD	TOP OF DUCT
FV	FACE VELOCITY	TSP	TOTAL STATIC PRESSURE
GA	GALLON	U	URINAL
GAL	GALLON	VAV	VARIABLE AIR VOLUME
GD	GARAGE DRAIN	VD	VOLUME DAMPER
GPM	GALLONS PER MINUTE	VFD	VARIABLE FREQUENCY DRIVE
HP	HORSEPOWER	VOL	VOLUME
HR	HOUR	VTR	VENT THROUGH ROOF
HT	HEIGHT	W/	WTH
IN.	INCH INCHES OF WATER COLUMN	<b>W/</b> 0	WITHOUT
INWC		WB	WET BULB
INWG	INCHES OF WATER GAUGE	WC	WATER CLOSET
L	LAVATORY OR LOUVER	MVD	MANUAL VOLUME DAMPER
LAT	LEAVING AIR TEMPERATURE	WCO	WALL CLEANOUT
LBS	POUNDS	WPD	WATER PRESSURE DROP
LWT	LEAVING WATER TEMPERATURE	WT	WEIGHT
MAX	MAXIMUM		/

ALTITUDE: 4,455 FT

SITE ATMOSPHERIC PRESSURE: 12.5 P.S.I.

### MECHANICAL LEGEND

NOTE: ALL ITEMS MAY NOT APPEAR ON DRAWINGS

GATE VALVE —	<b>→&gt;&gt;</b>	OVERFLOW DRAIN PIPING	<del></del> (	OD —
OS & Y PATTERN GATE VALVE —	<b>→</b> ▼	STORM DRAIN PIPING ABOVE	GRADE — S	SD —
BALL VALVE —	<b>−</b> 5−−	STORM DRAIN PIPING BELOW	GRADE S	SD
BUTTERFLY VALVE	<b>—</b> Ф——	FIRE SERVICE		F
MOTORIZED VALVE OPERATOR	M	NATURAL GAS		G——
GAS COCK —	<b>→</b>	HEAT TRACING	<del>//</del>	<del>//</del>
PLUG VALVE —		CHILLED WATER SUPPLY	—-с	HS
CHECK VALVE (SWING OR LIFT AS REQ'D) —	<u> </u>	CHILLED WATER RETURN	—-с	HR
SOLENOID VALVE —	<b></b> 晃	CONDENSER WATER SUPPLY	— 0	cs —
AUTOMATIC CONTROL VALVE (2-WAY) —	<b>→</b> \$	CONDENSER WATER RETURN	— (	CR —
AUTOMATIC CONTROL VALVE (3-WAY) —	<b>−⅓−−</b>	HEATING WATER SUPPLY	—-н	ws
PRESSURE REDUCING VALVE —	<b>-</b> \$↓	HEATING WATER RETURN	—-н	WR
P & T RELIEF VALVE	<b></b>	RADIANT FLOOR SUPPLY	——R	FS
AIR VENT (AUTOMATIC) —	<b>_</b>	RADIANT FLOOR RETURN	——R	FR
CURB COCK —	—⊗—	STEAM		s——
THERMAL EXPANSION VALVE —	—⊗—	REFRIGERANT LIQUID	— r	RL —
STRAINER —	<del></del>	REFRIGERANT SUCTION	— F	<b>≈</b>
CALIBRATED BALANCE VALVE —	<del></del>	HOT GAS	<u>—</u> н	IG —
VENTURI FLOW METER -	<b>─</b> ₩	HOT GAS BYPASS	— но	GBP ——
REDUCER —	<b>—</b> D——	DUCT SIZE, FIRST FIGURE IS	SIDE SHOWN 18/	12
PET COCK OR GAUGE COCK —		BURIED OR UNDERFLOOR DU	CT <b>£</b> ==	3
PRESSURE GAUGE W/GAUGE COCK	<u> </u>	DUCT W/ ACOUSTICAL LINING	;	
THERMOMETER		FLEXIBLE DUCT (HELICAL)		~
TEMPERATURE & PRESSURE TEST PLUG -	<u> </u>	SPIN-IN FITTINGS W/MVD	<i>ډ</i> ځځ :	= =
IN-LINE PUMP —		FLEXIBLE DUCT CONNECTION		
FLOW SWITCH —	<u>F</u>	SUPPLY SLOT DIFFUSER		<u> </u>
AQUASTAT —	<u> </u>	SUPPLY DIFFUSER	₽	₫
HOSE BIBB OR SILLCOCK —	<del>&gt;+</del>	RETURN GRILLE		1
YARD HYDRANT —	<b>—</b>	RADIAL SUPPLY DIFFUSERS	€	
FLOOR DRAIN		RETURN AIR DUCT SECTION		$\bigcirc$
FLOOR SINK		RETURN AIR DUCT UP		$\bigcirc$
MANHOLE	<u> </u>	RETURN AIR DUCT DOWN		$\bigcirc$
WALL CLEANOUT	<del>-</del> GII	SUPPLY AIR DUCT SECTION	$\boxtimes$	$\bigotimes$
FLOOR OR GRADE CLEANOUT -	<del>ф</del>	SUPPLY AIR DUCT UP	$\boxtimes$	$\bigotimes$
GRADE CLEANOUT W/ CONCRETE PAD -	<del>_</del> Ф_	SUPPLY AIR DUCT DOWN	$\boxtimes$	$\bigotimes$
VENT THROUGH ROOF	_//_	EXHAUST AIR DUCT SECTION		$\bigotimes$
POST TYPE FDC CONNECTION	,Q,	EXHAUST AIR DUCT UP		$\bigotimes$
WALL TYPE FDC CONNECTION		EXHAUST AIR DUCT DOWN		$\bigotimes$
FIRE HOSE CABINET	<u> 2020</u>	ACCESS PANEL	<u>/</u>	<u></u> t
FIRE DEPT. HORN & LIGHT	- DO	MANUAL VOLUME DAMPER	1	<u> </u>
EXPANSION JOINT -	<del></del>	GRAVITY BACKDRAFT DAMPE	R E	<b></b> →
FLEXIBLE PIPE CONNECTION —		MOTORIZED DAMPER		<b>=</b>
REDUCED PRESSURE BACKFLOW PREVENTER —	—RPBP——	FIRE DAMPER	E	<del>I</del> -©
DIRECTION OF FLOW —	-	SMOKE DAMPER		<u>-</u> + s
ELBOW DOWN —	<del></del> 5	COMBINATION FIRE/SMOKE D	AMPER <u> </u>	<u>- + ®</u>
ELBOW UP —	<del></del> 0	DUCT TRANSITION	<b>5</b> ——	<b>►</b>
PIPE CAP —	<del></del>	ELBOW W/ TURNING VANES	, <del>\ _=</del> \	7 = + <del> </del>
TEE DOWN —	<del></del>	TEE W/ 45° ENTRY	<u>, , , , , , , , , , , , , , , , , , , </u>	
UNION	<b>  </b>	WYE W/ 45° ENTRY	<b>,</b> =	
DOMESTIC COLD WATER —	<del></del>	THERMOSTAT OR TEMP SENS		D .
DOMESTIC HOT WATER —	<del></del>	HUMIDISTAT OR HUMIDITY SE	113011	H)
HOT WATER CIRC.		POINT OF REMOVAL FROM EX		<b>8</b> <b>9</b>
TEMPERED WATER —	—т—	POINT OF CONNECTION TO E	AISTING	
SANITARY (PLBG) VENT		DETAIL TAG	DETAIL NO. DRAWING NO.	<b>ラ</b>
SANITARY SEWER ABOVE GRADE		KEYED NOTE	NOTE NO.	<del>-</del> >
SANITARY SEWER BELOW GRADE			SECTIONS NO.	
DRAIN — ROOF DRAIN PIPING —	— D———————————————————————————————————	SECTION CUT LINE	DRAWING NO.	
NOUL DIVAIN FILING	NU <del></del>			





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Telefax (801) 595-6717
www.mhtn.com

LIND LECTURE HALL REMODEL
WEBER STATE UNIVERSITY
OGDEN CAMPUS OGDEN, UTA
UTAH STATE DIVISION OF
FACILITIES CONSTRUCTION & MANAGEMENT
DFCM PROJECT NO. 04040810

	PROJECT NO. PROJECT NO. BY: GR	2005605 CHECKED BY: BRC
ISSUED	:	
NO.	DATE	DESCRIPTION
1	4/11/06	95% REVIEW SET
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REVISIONO.	DNS:	DESCRIPTION
		DESCRIPTION

LEGENDS AND ABBREVIATIONS

CD DOCUMENTS DATE 4/20/06

SHEET NUMBER

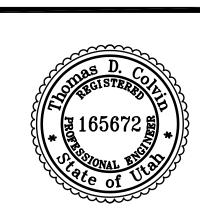
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### LIND LECTURE HALL REMODEL WEBER STATE UNIVERSITY OGDEN CAMPUS OGDEN, UTAH STATE DIVISION OF FACILITIES CONSTRUCTION & MANAGEMENT DECM PROJECT NO. 04040810



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DFCM PI	ROJECT NO. ROJECT NO. BY: GR	2005605 CHECKED BY: BRC	
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### GROUND FLOOR MECHANICAL REMODEL PLAN

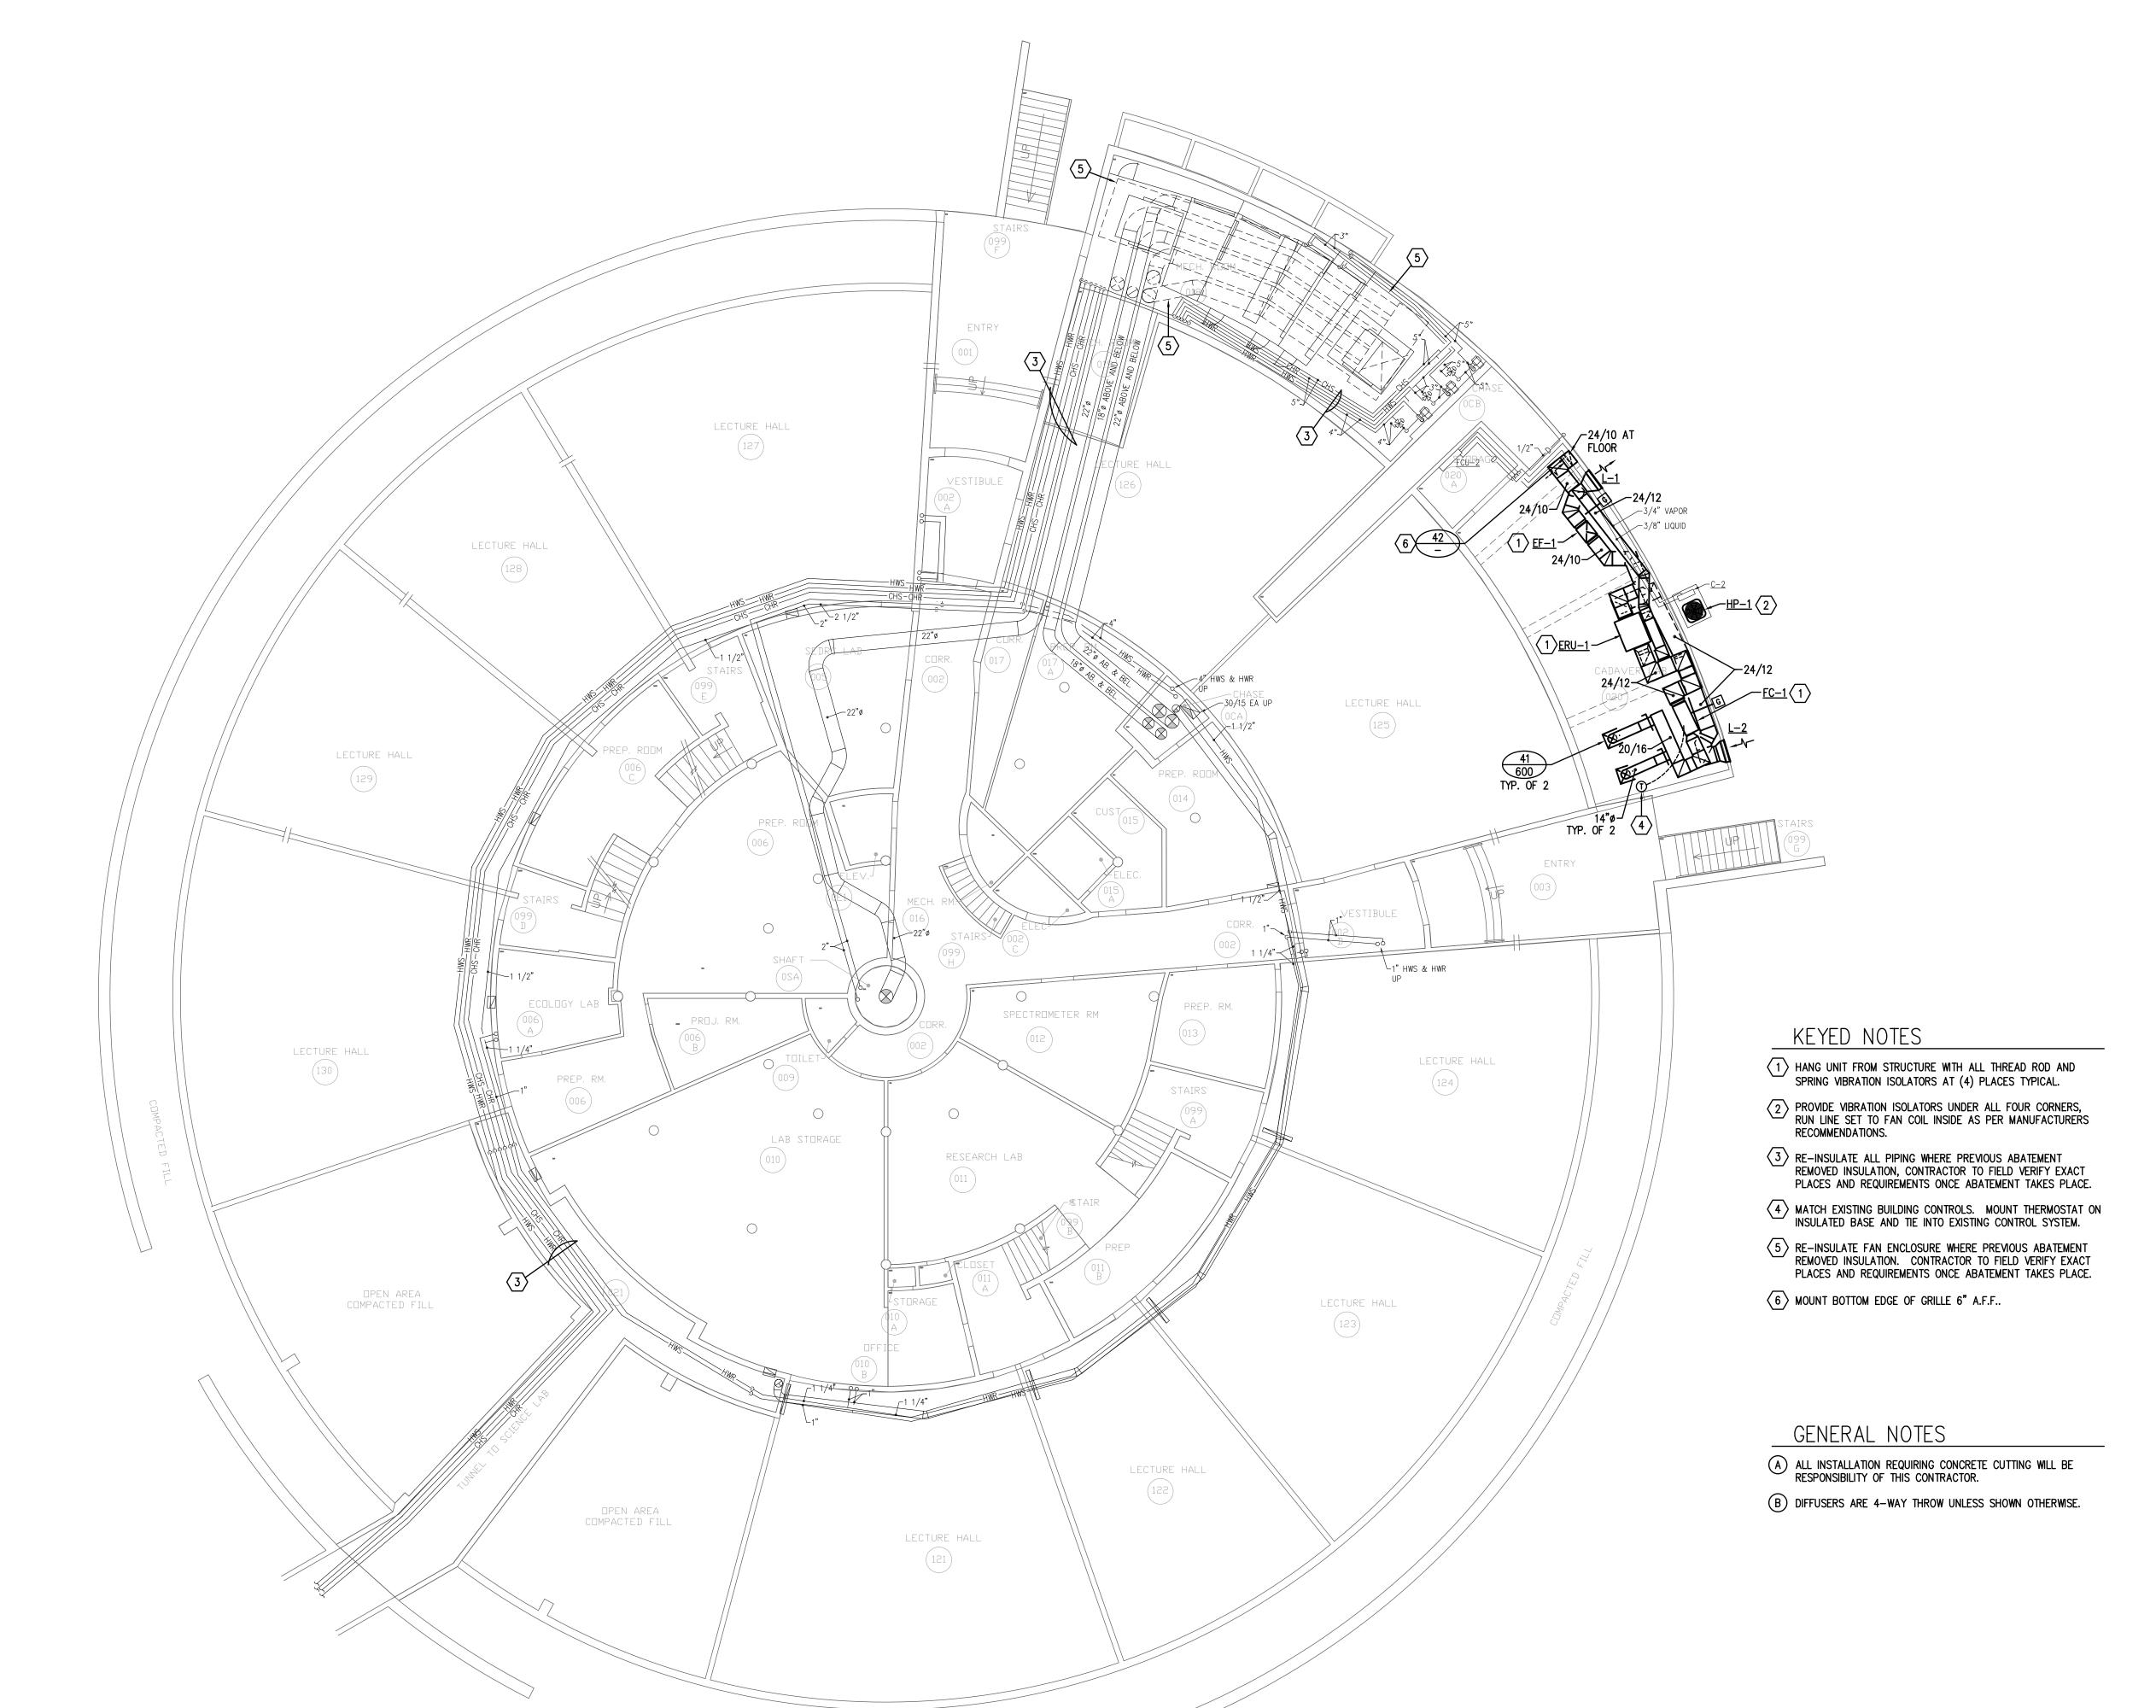
CD DOCUMENTS DATE 4/20/06

MH200

Engineering

244 West 300 North Suite 200 Salt Lake City, Utah 84103 Phone (801) 322-2400 / Fax: (801) 322-2416

Associates, Inc.



GROUND FLOOR MECHANICAL REMODEL PLAN

SCALE: 3/32" = 1'-0"

6' 0 4' 8' 12' 16' 24'

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FIRST FLOOR MECHANICAL REMODEL PLAN

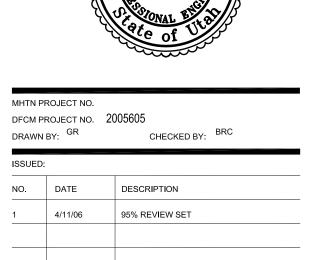
SCALE: 3/32" = 1'-0"

6' 0 4' 8' 12' 16' 24'



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### WEBER OGDEN UTAH STAT FACILITIES DFCM PRO



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FIRST FLOOR MECHANICAL REMODEL PLAN

CD DOCUMENTS DATE 4/20/06

SHEET NUMBER

MH201

KEYED NOTES

PARTITION \_\_\_\_ STORAGE

 $\langle 1 \rangle$  connect existing piping to New convector same size. (2) MATCH EXISTING CONTROLS IN BUILDING AND TIE INTO EXISTING CONTROL SYSTEM.

GENERAL NOTES

ALL INSTALLATION REQUIRING CONCRETE CUTTING WILL BE RESPONSIBILITY OF THIS CONTRACTOR.

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# LIND LECTURE HALL REMODEL WEBER STATE UNIVERSITY OGDEN CAMPUS OGDEN, UTAH FACILITIES CONSTRUCTION & MANAGEMENT DFCM PROJECT NO. 04040810

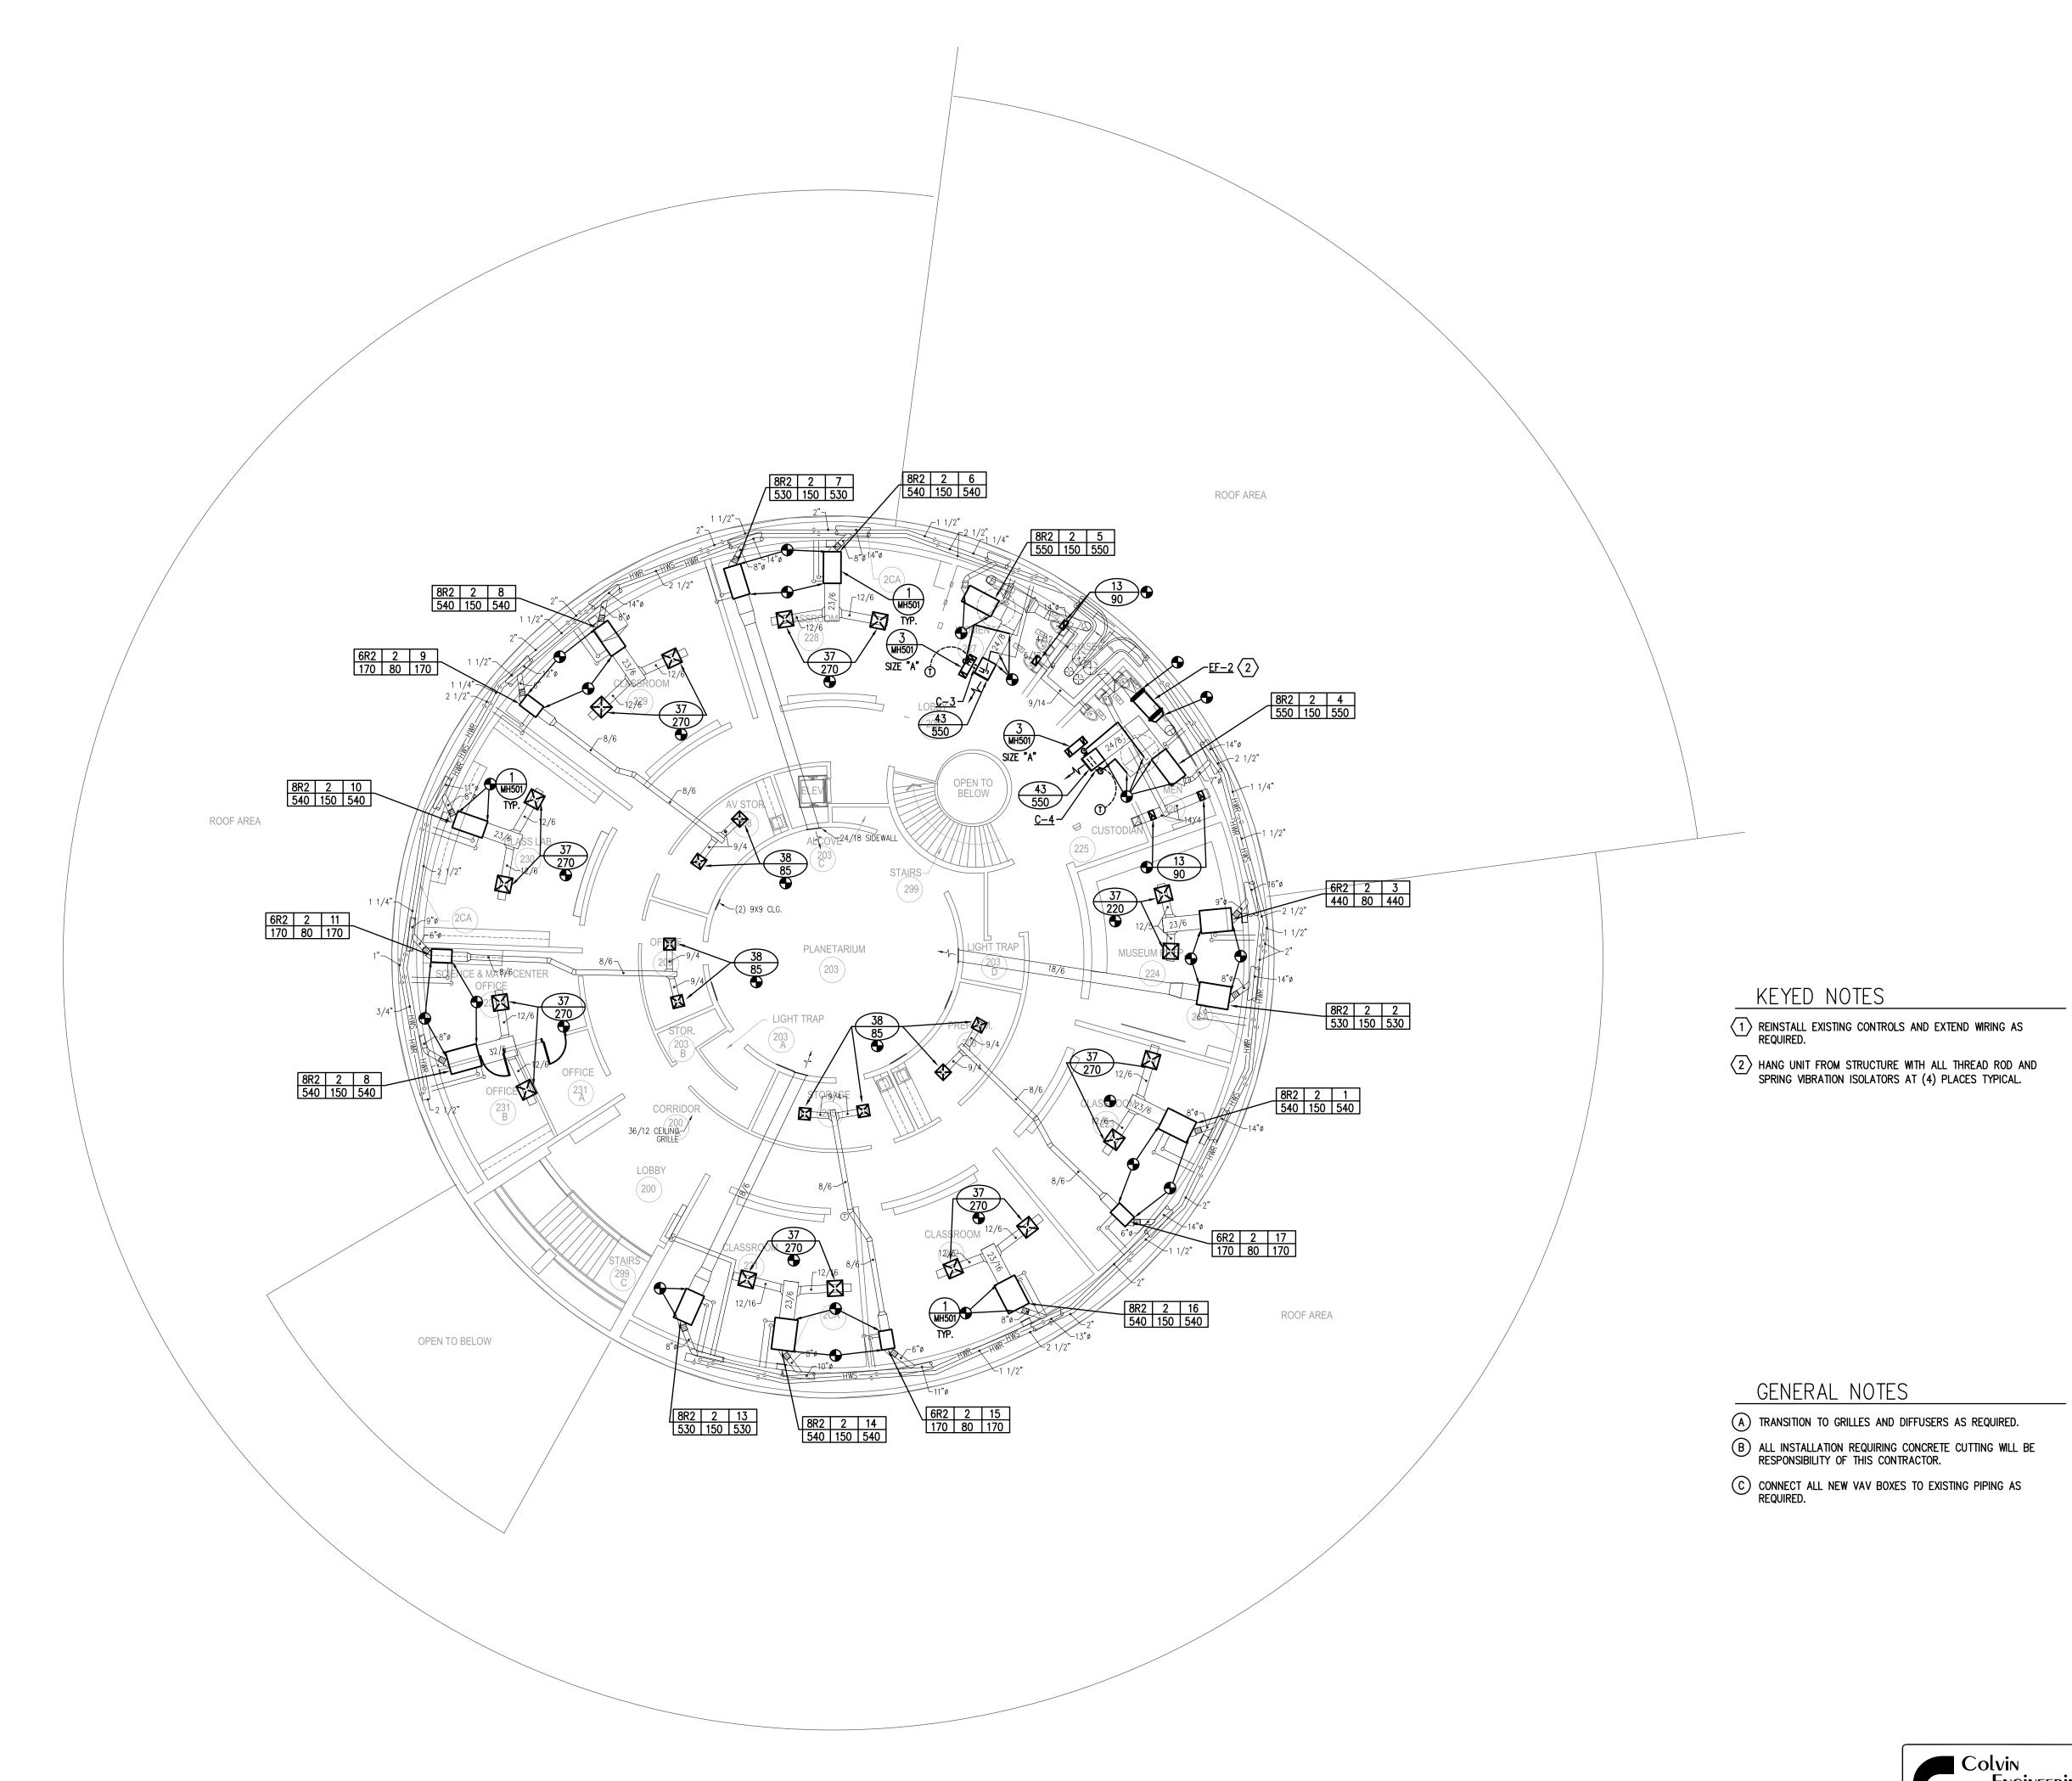
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### SECOND FLOOR MECHANICAL REMODEL PLAN

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SECOND FLOOR MECHANICAL REMODEL PLAN

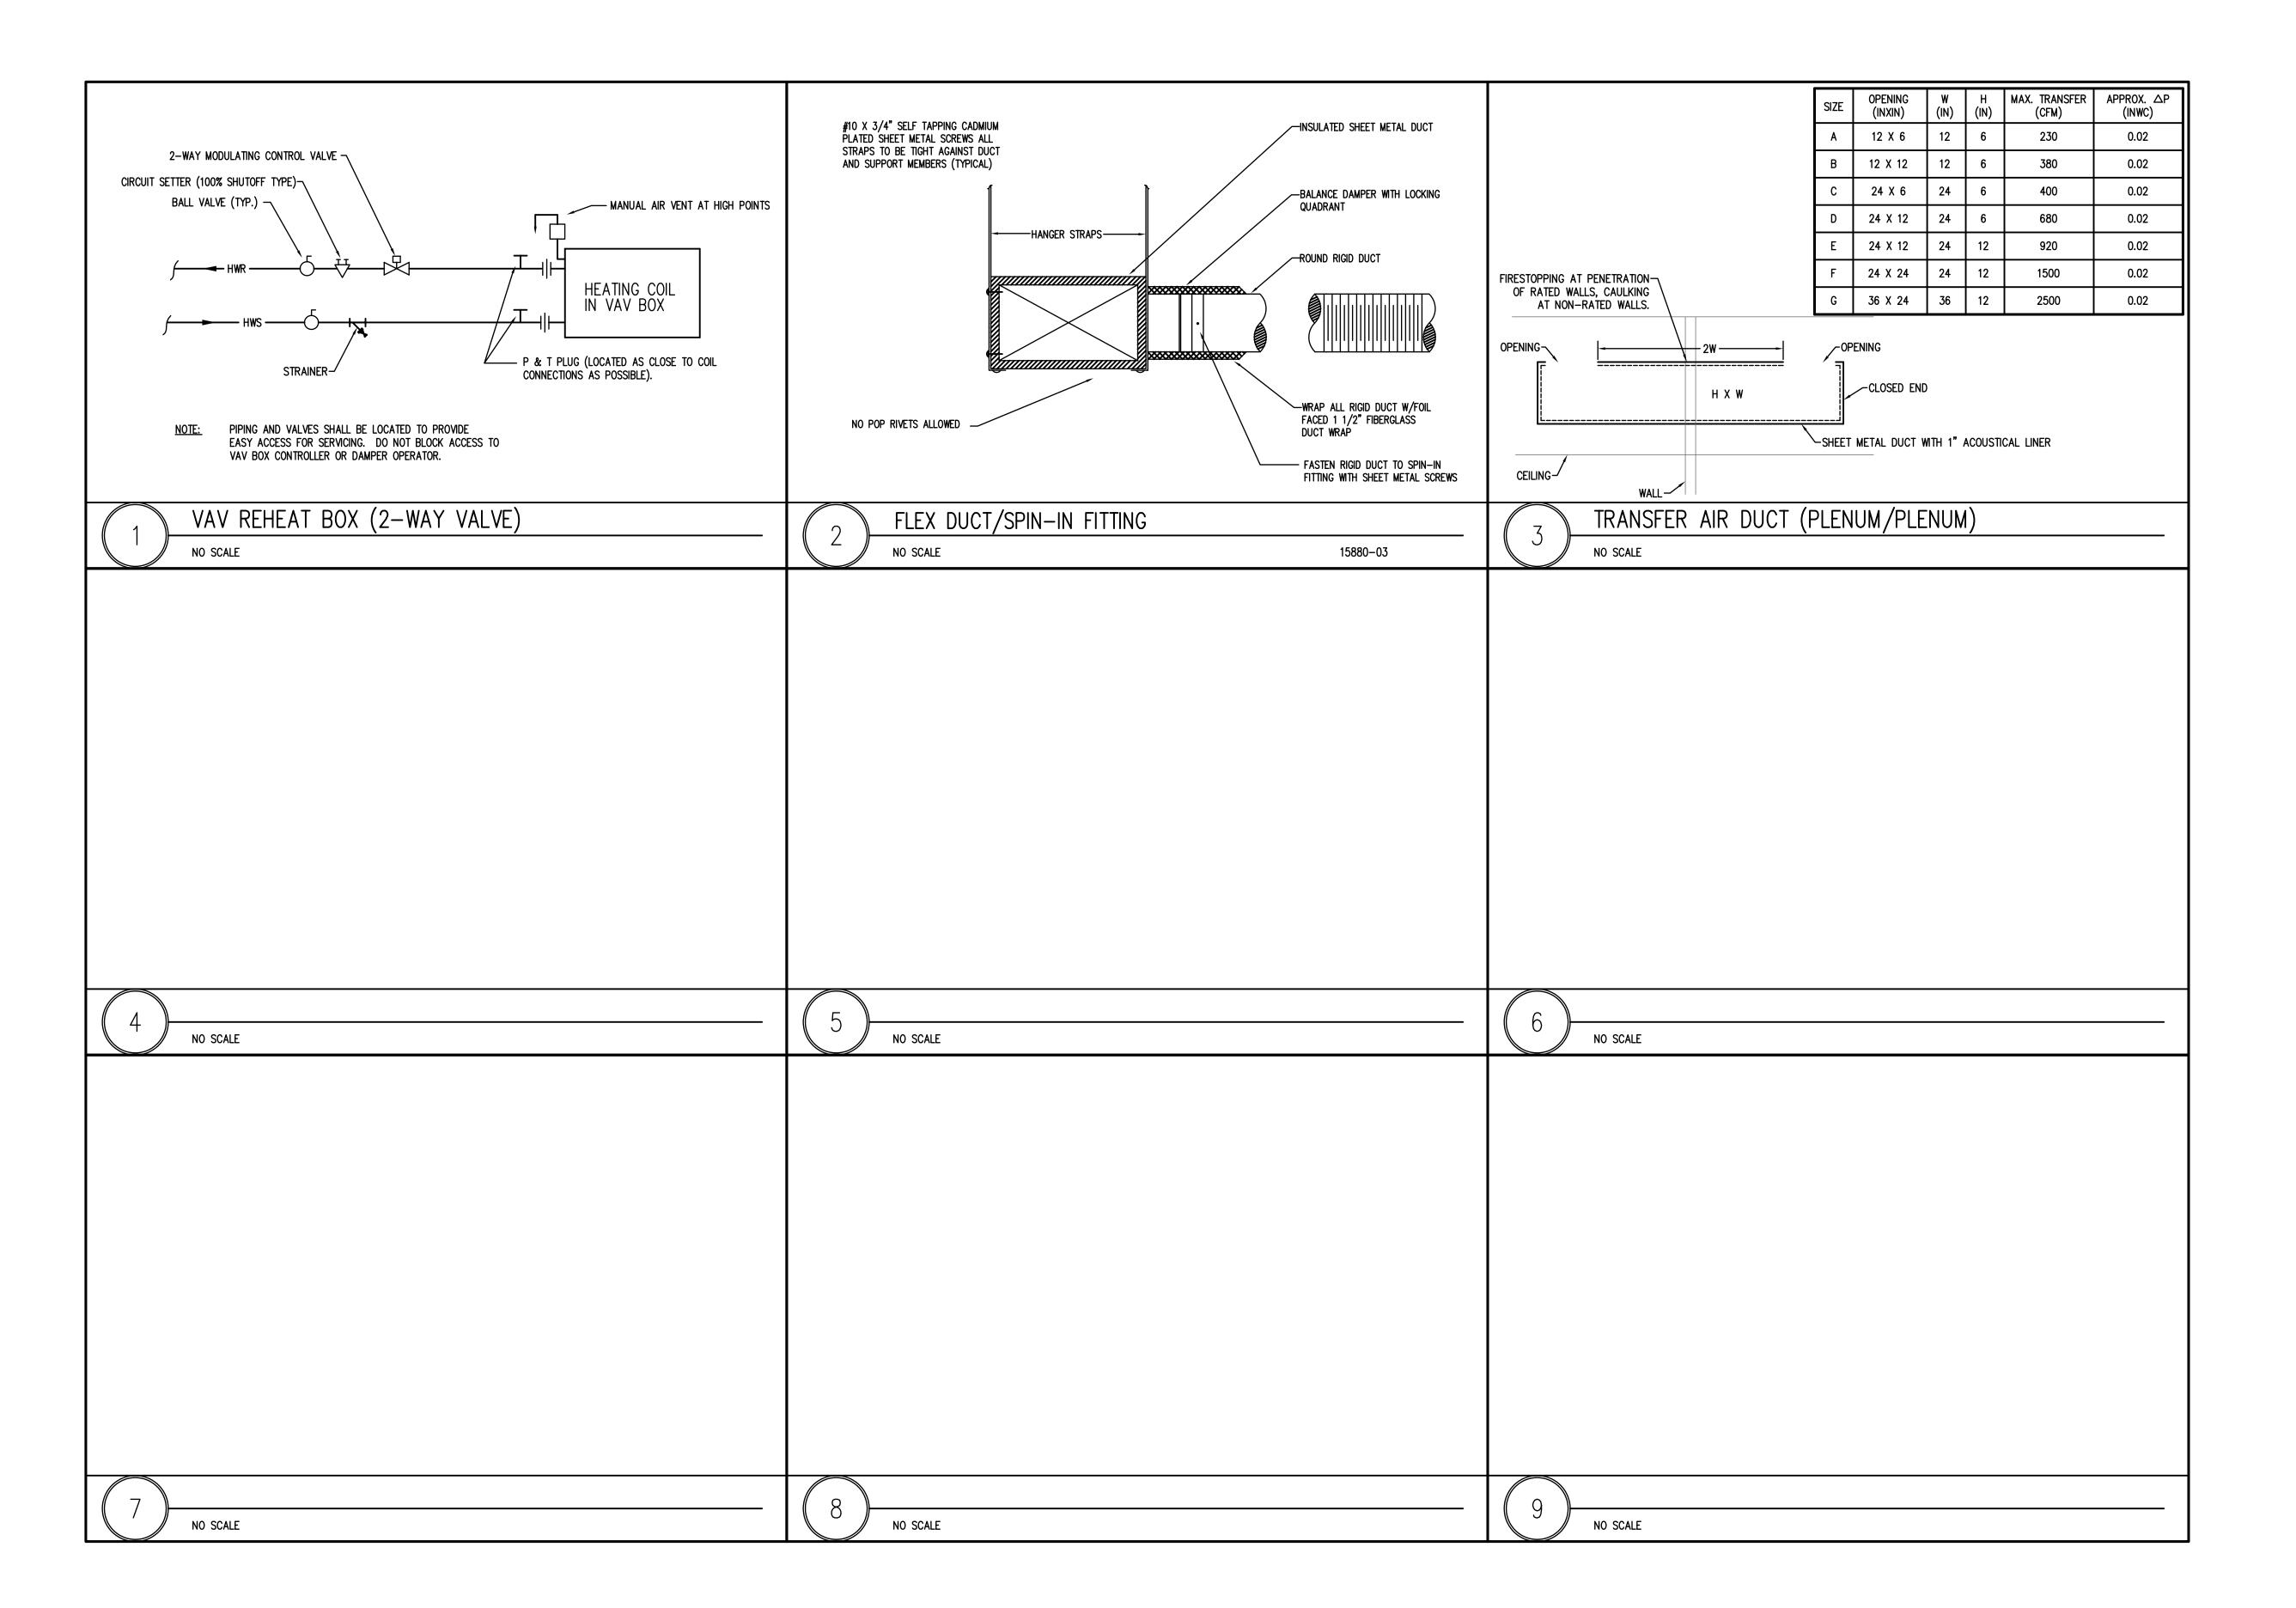
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# LIND LECTURE HALL REMODEL WEBER STATE UNIVERSITY OGDEN CAMPUS OGDEN, UTAH TATE DIVISION OF FACILITIES CONSTRUCTION & MANAGEMENT DFCM PROJECT NO. 04040810



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MECHANICAL DETAILS

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MH501

	LOUVER SCHEDULE 1													
PLAN CODE	CFM VELOCITY FPM PRESSURE DROP (IN WC) FREE AREA SQ. FT. MAX. DIMENSIONS (W x H) & MANUFACTURER & MODEL NO.													
L-1	1200	500	0.12	2.9	36 X 24	AIROLITE K6776								
L-2														

$\bigcirc$	BIRDSCREEN
しい	DINDOCKEEN

	IN-LINE EXHAUST FAN SCHEDULE																													
PLAN	ADEA		CFM @	ren.	FAN		МО	TOR			DAMPED	METHOD OF		DIMENSIONS		DIMENSIONS		DIMENSIONS		DIMENSIONS		DIMENSIONS		DIMENSIONS		DIMENSIONS		MAX.		
CODE	AREA SERVED	TYPE	ELEV.	ESP (@ ELEV.)	FAN RPM	B.H.P.	H.P.	EFFICIENY %	VOLTAGE & PHASE	SONES	DAMPER (GRAVITY OR MOTOR)	METHOD OF CONTROL	L (IN)	W (IN)	H (IN)	OPERATING WT. (LBS.)	MANUFACTURER / MODEL	REMARKS												
EF-1	CADAVER LAB	WALL MOUNT	1500	.9	1285	0.513	3/4	PREMIUM	208/3	15.8	GRAVITY	INTERLOCK W/ FCU-1	26	22	28	230	COOK DBX-9	INTERLOCK WITH FAN COIL UNIT SPEED CONTROLER FOR FAN												
EF-2	RESTROOMS	INLINE	900	1.25	1742	0.364	1/2	PREMIUM	115/1	16.3	GRAVITY	LIGHT SWITCH	23	18	34	200	COOK SQN-HP	-												

	FAN COIL UNIT SCHEDULE																				
					ŀ	HEATING COIL			ELECTRI	C HEAT (1)	)		COOLIN	IG COIL			MAX. DIM	IENSIONS			
PLAN CODE	CFM	ESP (IN WC)	FAN HP	VOLT/PH	CAPACITY (MBH)	EAT/LAT (°F)	AIR PD (IN WC)	KW	EAT/LAT	MCA	MOCP	CAPACITY (MBH)	EAT (DB/WB) (℉)	LAT (DB/WB) (°F)	AIR PD (IN WC)	LENGTH (IN)	WIDTH (IN)	HEIGHT (IN)	OPERATING WT. (LBS.)	MANUFACTURER & MODEL NO	ACCESSORIES
FC-1	1200	40	113	208/3	35	50.9/60.9	-	15	60.9/98.7	70.8	80	30.8	80.8/57.7	50.7/41.6	-	50	18	23	350	CARRIER FB4-036	- -

1 CARRIER FACTORY INSTALLED ELECTRICAL HEAT MODEL# FA4ANF036015

	HEAT PUMP UNIT SCHEDULE														
PLAN	SYSTEM	NOMINAL	El	LECTRICAL		MANUFACTURER		MAX.	DIMENSIONS						
CODE	SERVED	TONS	VOLTAGE & PHASE	MCA	MOCP	& MODEL NO.	LENGTH (IN.)	WIDTH (IN.)	HEIGHT (IN.)	OPERATING WT. (LBS)	REMARKS				
CU-1	FC-1	3	208/3	15.7	20	CARRIER 38YCC036	30	30	28	200	LOW AMBIENT KIT, R-22 REFRIGERANT ANCHOR TO CONCRETE PAD.				

	ENERGY RECOVERY UNIT ①																		
					SUPPL	Y FAN						ENERGY REC	OVERY UNIT		M	AX. DIMENSION	NS .		
PLAN CODE	AREA/UNIT SERVED	CFM (ELEV.)	ESP (S.L.)	H.P.	B.H.P.	RPM	VOLTAGE & PHASE	MCA	МОСР	OUTDOOR EAT (DB) 'F WINTER	OUTDOOR EAT (DB/WB) 'F SUMMER	INDOOR EAT (DB/WB) F	LAT (DB) F WINTER	LAT (DB/WB) F SUMMER	LENGTH (IN)	WIDTH (IN)	HEIGHT (IN)	OPERATING WT.(LBS.)	MANUFACTURER & MODEL NO.
ERU-1														RENEWAIRE HE2XINH					

1) INTERLOCK WITH FAN COIL UNIT.

	V	AV REHE	EAT					PLAN C MAX COOLING MIN. COOLING	CFM——	FLOO BOX MAX		-M
PLAN	INLET SIZE	MAX. COOLING	MAX.	△ P @ MAX.	MIN. CONTROL				HW COIL		1	
CODE	(IN)	AIR FLOW (CFM)	NC	AIR FLOW (IN WC)	(CFM)	EAT (°F)	MIN LAT (°F)	MAX. HEATING (CFM)	ROWS	MAX. GPM @180°F	MAX. WPD (FT.)	COIL MBH
6R2	6	500	31	0.53	80	55	88	500	2	0.6	0.1	15.0
8R2	8	800	29	0.48	150	55	88	800	2	0.9	0.3	24.0

PERFORMANCE AT 4500 FT. ELEVATION.

Alf	AIR DEVICE SCHEDULE  PLAN CODE GRILLE CFM														
PLAN CODE	TYPE & DUTY	FACE SIZE	neck Size	*2 CEILING TYPE	MAX. CFM	MAX. T.P. (IN. W.C.)	N.C. LEVEL MAX	MIN. THROW (FT) (T50)		2-WAY MIN. THROW (T50)	MANUFACTURER & MODEL NO.	REMARKS			
13	PERFORATED EXHAUST GRILLE	14" X 8"	12" X 6"	MATCH CEILING	123	0.03	-	-	-	-	TITUS 8F	-			
37	ADJUSTABLE LOUVERED	14" X 14"	12" X 12"	MATCH CEILING	300	0.042	-	ADJUSTABLE	16	-	TITUS TDCA	-			
38	ADJUSTABLE LOUVERED	11" X 11"	9" X 9"	MATCH CEILING	170	0.042	-	ADJUSTABLE	12	-	TITUS TDCA	-			
41	SUPPLY DIFFUSER	24" X 24"	14 <b>"</b> ø	MATCH CEILING	641	0.08	22	21	-	-	TITUS TDCA	-			
42	LOW SIDEWALL RETURN	48" X 24"	46" X 22"	-	1336	0.008	27	_	-	-	TITUS 350FL	BLADES TO RUN PARALLEL TO FLOOR, ALUMINUI			
43	SIDEWALL SUPPLY	26" X 10"	24" X 8"	-	685	0.03	13	26	-	-	TITUS 271FL	BLADES TO RUN PARALLEL TO FLOOR, ALUMINU			
49	SIDEWALL GRILLE	32" X 10"	30" X 8"	SURFACE	555	0.05	12	_	-	-	TITUS 271FL	BLADES TO RUN PARALLEL TO FLOOR, ALUMINUM			

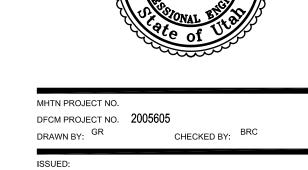
(\*1) RECOMMENDED MIN. DISTANCE BETWEEN DIFFUSERS IN 9' CEILING.

		(*2) VE	RIFY FRAME TYP	PE OF ALL A	AIR DEVICES W	ITH ARCHITECTU	IRAL REFLECT	ED CEILING PL	.an before (	ORDERING.					
								CONV	ECTOR						
PLAN CAPACITY		FLOW	AVERAGE	π	JBE	FINS			COVER				MOUNTING	MANUFACTURER	
CODE		RATE (GPM/LF)	WATED TEMP	SIZE	MATERIAL	SIZE	SPACING F.P.I.	MATERIAL	HEIGHT	DEPTH	STYLE	LENGTH	HEIGHT TO TOP OF COVER	& MODEL NO.	REMARKS
C-1	3.9	.5	170 <b>°</b> F	1/2"	COPPER	2-3/4" x 3"	4	ALUMINUM	26"	6 <b>"</b>	PR	32"	MATCH EXISTING	AIRTHERM 32-6-26	WITH DANFOSS SELF- CONTAINED VALVE
C-2	3.9	.5	170°F	1/2"	COPPER	2-3/4" x 3"	4	ALUMINUM	26"	6 <b>"</b>	PR	32"	MATCH EXISTING	AIRTHERM 32-6-26	WITH DANFOSS SELF- CONTAINED VALVE
C-3	3.9	.5	170°F	1/2"	COPPER	2-3/4" x 3"	4	ALUMINUM	26"	6 <b>"</b>	PR	32"	MATCH EXISTING	AIRTHERM 32-6-26	WITH DANFOSS SELF- CONTAINED VALVE
C-4	3.9	.5	170 <b>°</b> F	1/2"	COPPER	2-3/4" x 3"	4	ALUMINUM	26"	6"	PR	32"	MATCH EXISTING	AIRTHERM 32-6-26	WITH DANFOSS SELF- CONTAINED VALVE





# LIND LECTURE HALL REMODEL WEBER STATE UNIVERSITY OGDEN CAMPUS OGDEN, UTAH TATE DIVISION OF FACILITIES CONSTRUCTION & MANAGEMENT DFCM PROJECT NO. 04040810



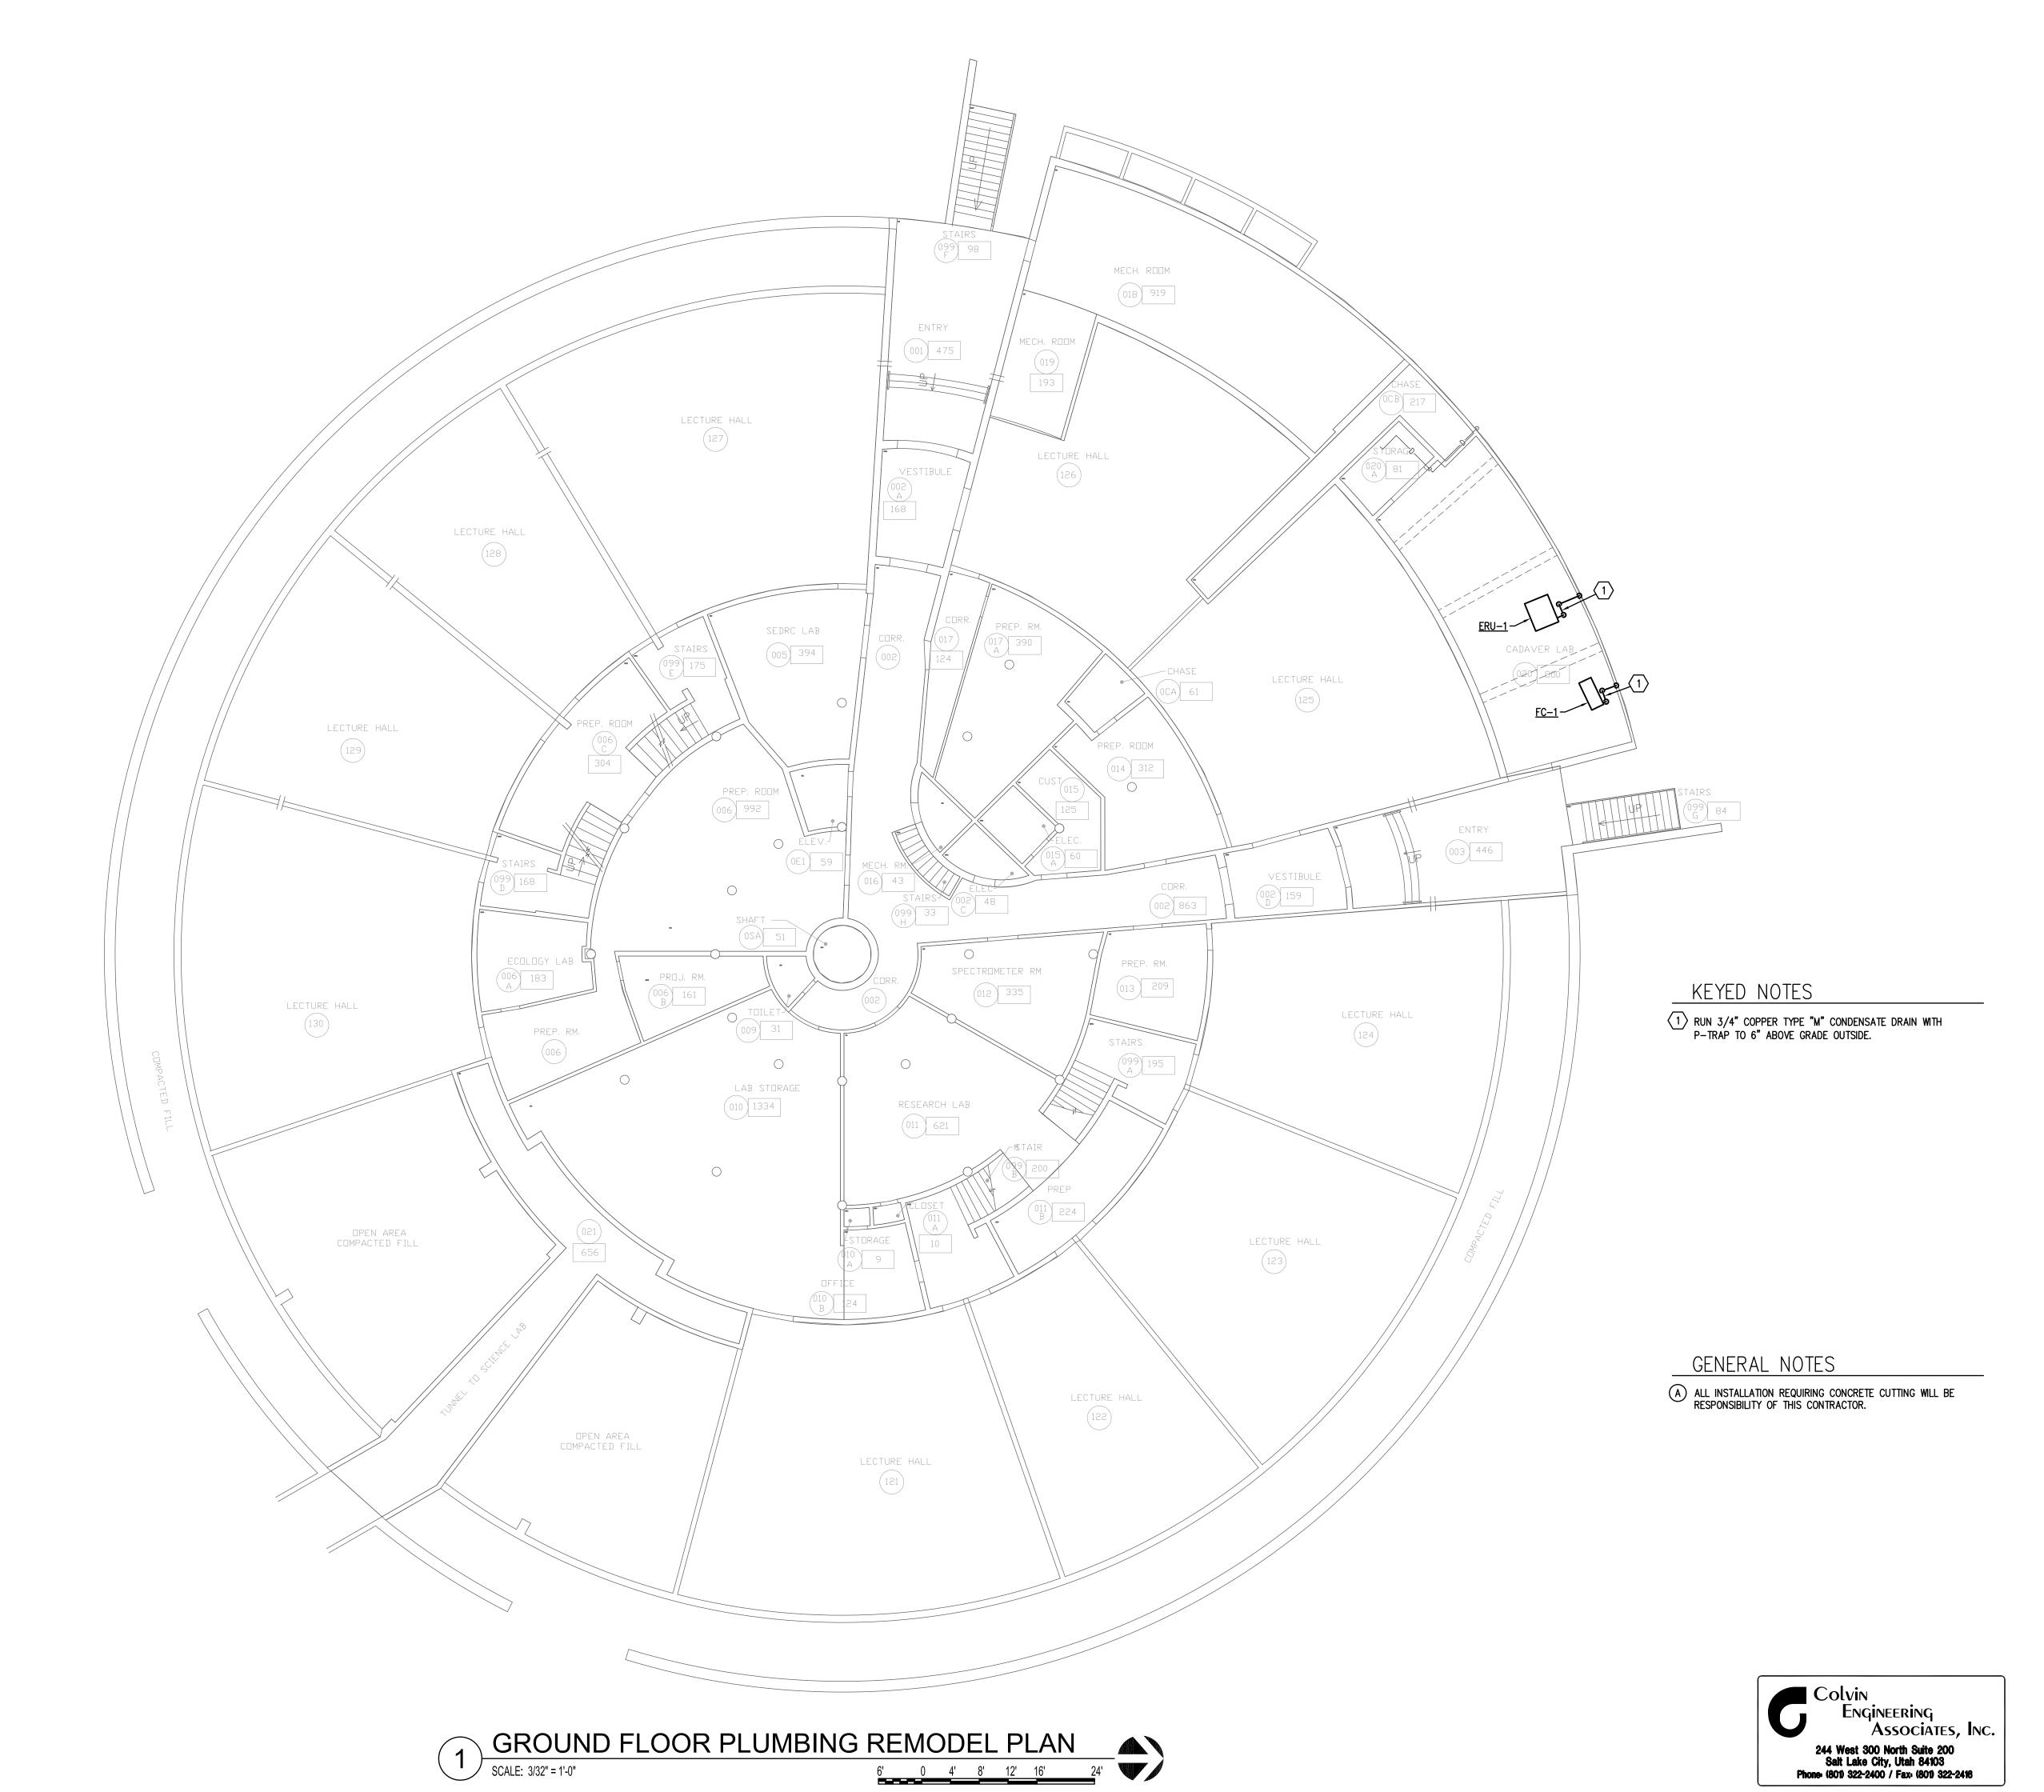
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### MECHANICAL SCHEDULES

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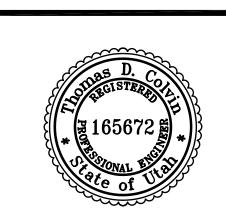
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UTAH STATE DIVISION OF
FACILITIES CONSTRUCTION & MANAGEMENT
DFCM PROJECT NO. 04040810



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### GROUND FLOOR PLUMBING REMODEL PLAN

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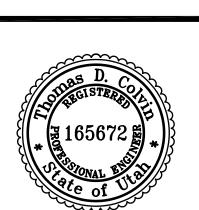
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# UIND LE WEBER OGDEN UTAH STAT FACILITIES DFCM PRO.



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### FIRST FLOOR PLUMBING REMODEL PLAN

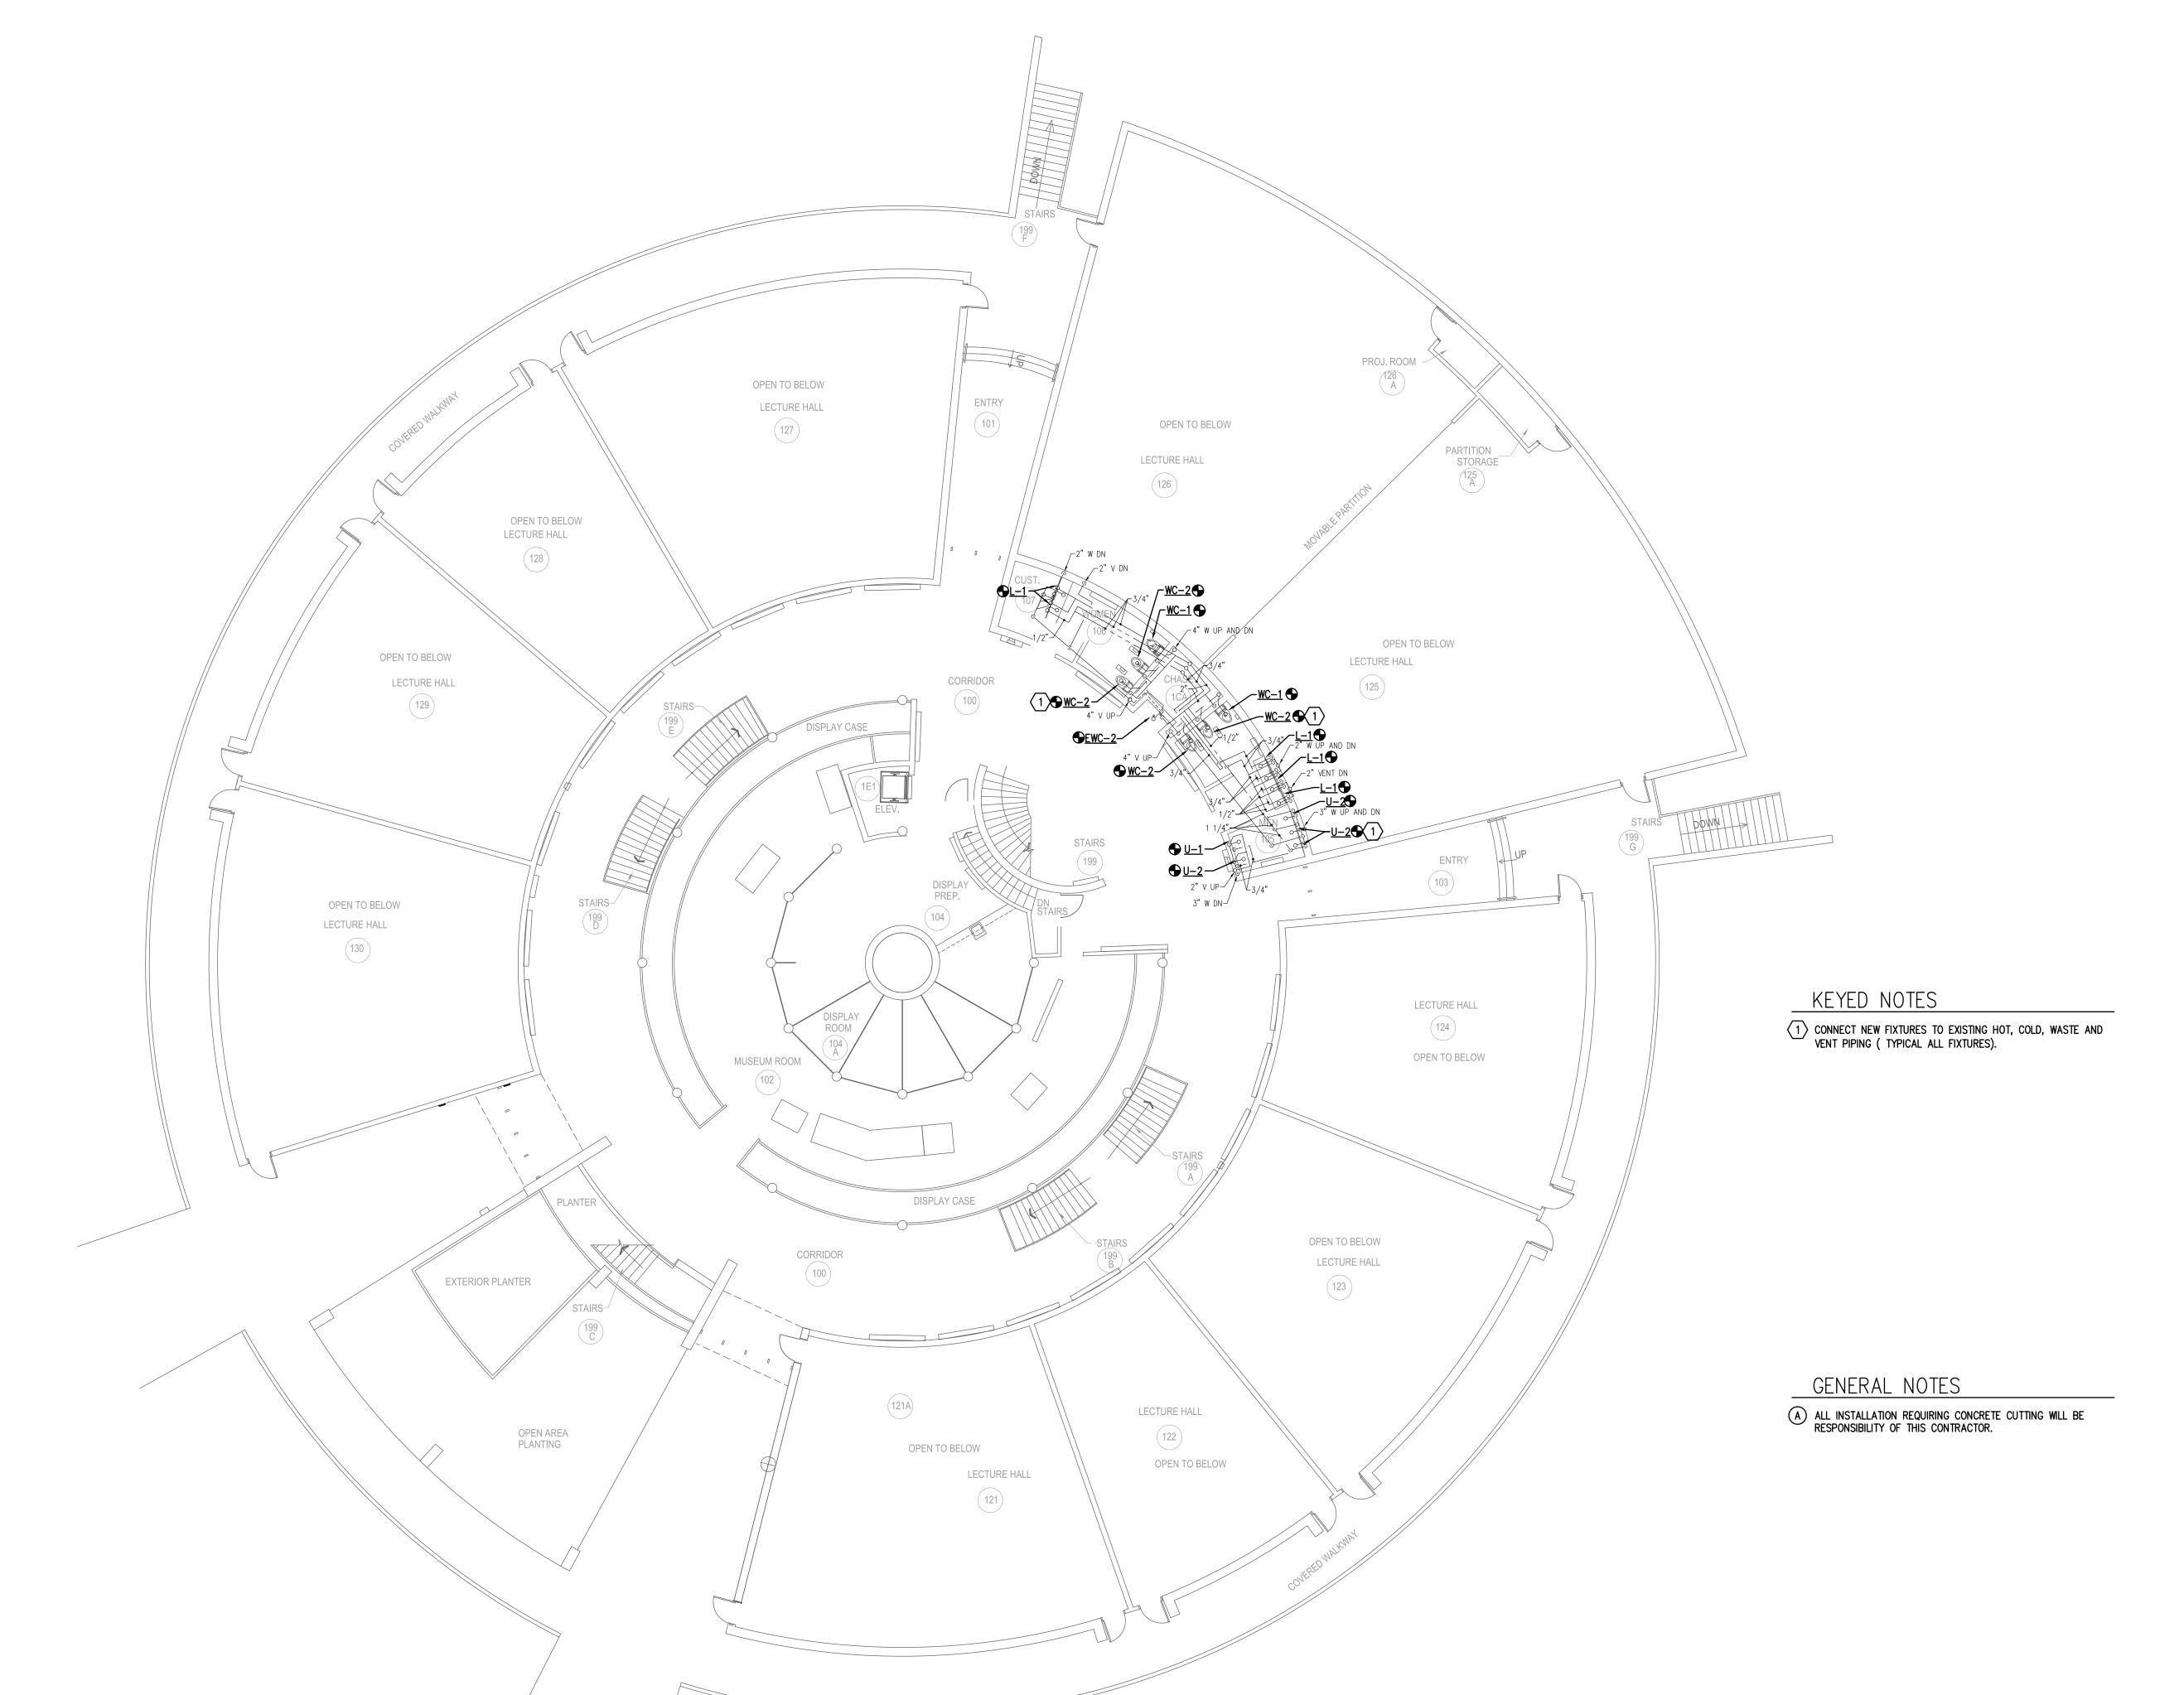
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PL201



FIRST FLOOR PLUMBING REMODEL PLAN

SCALE: 3/32" = 1'-0"

6' 0 4' 8' 12' 16'

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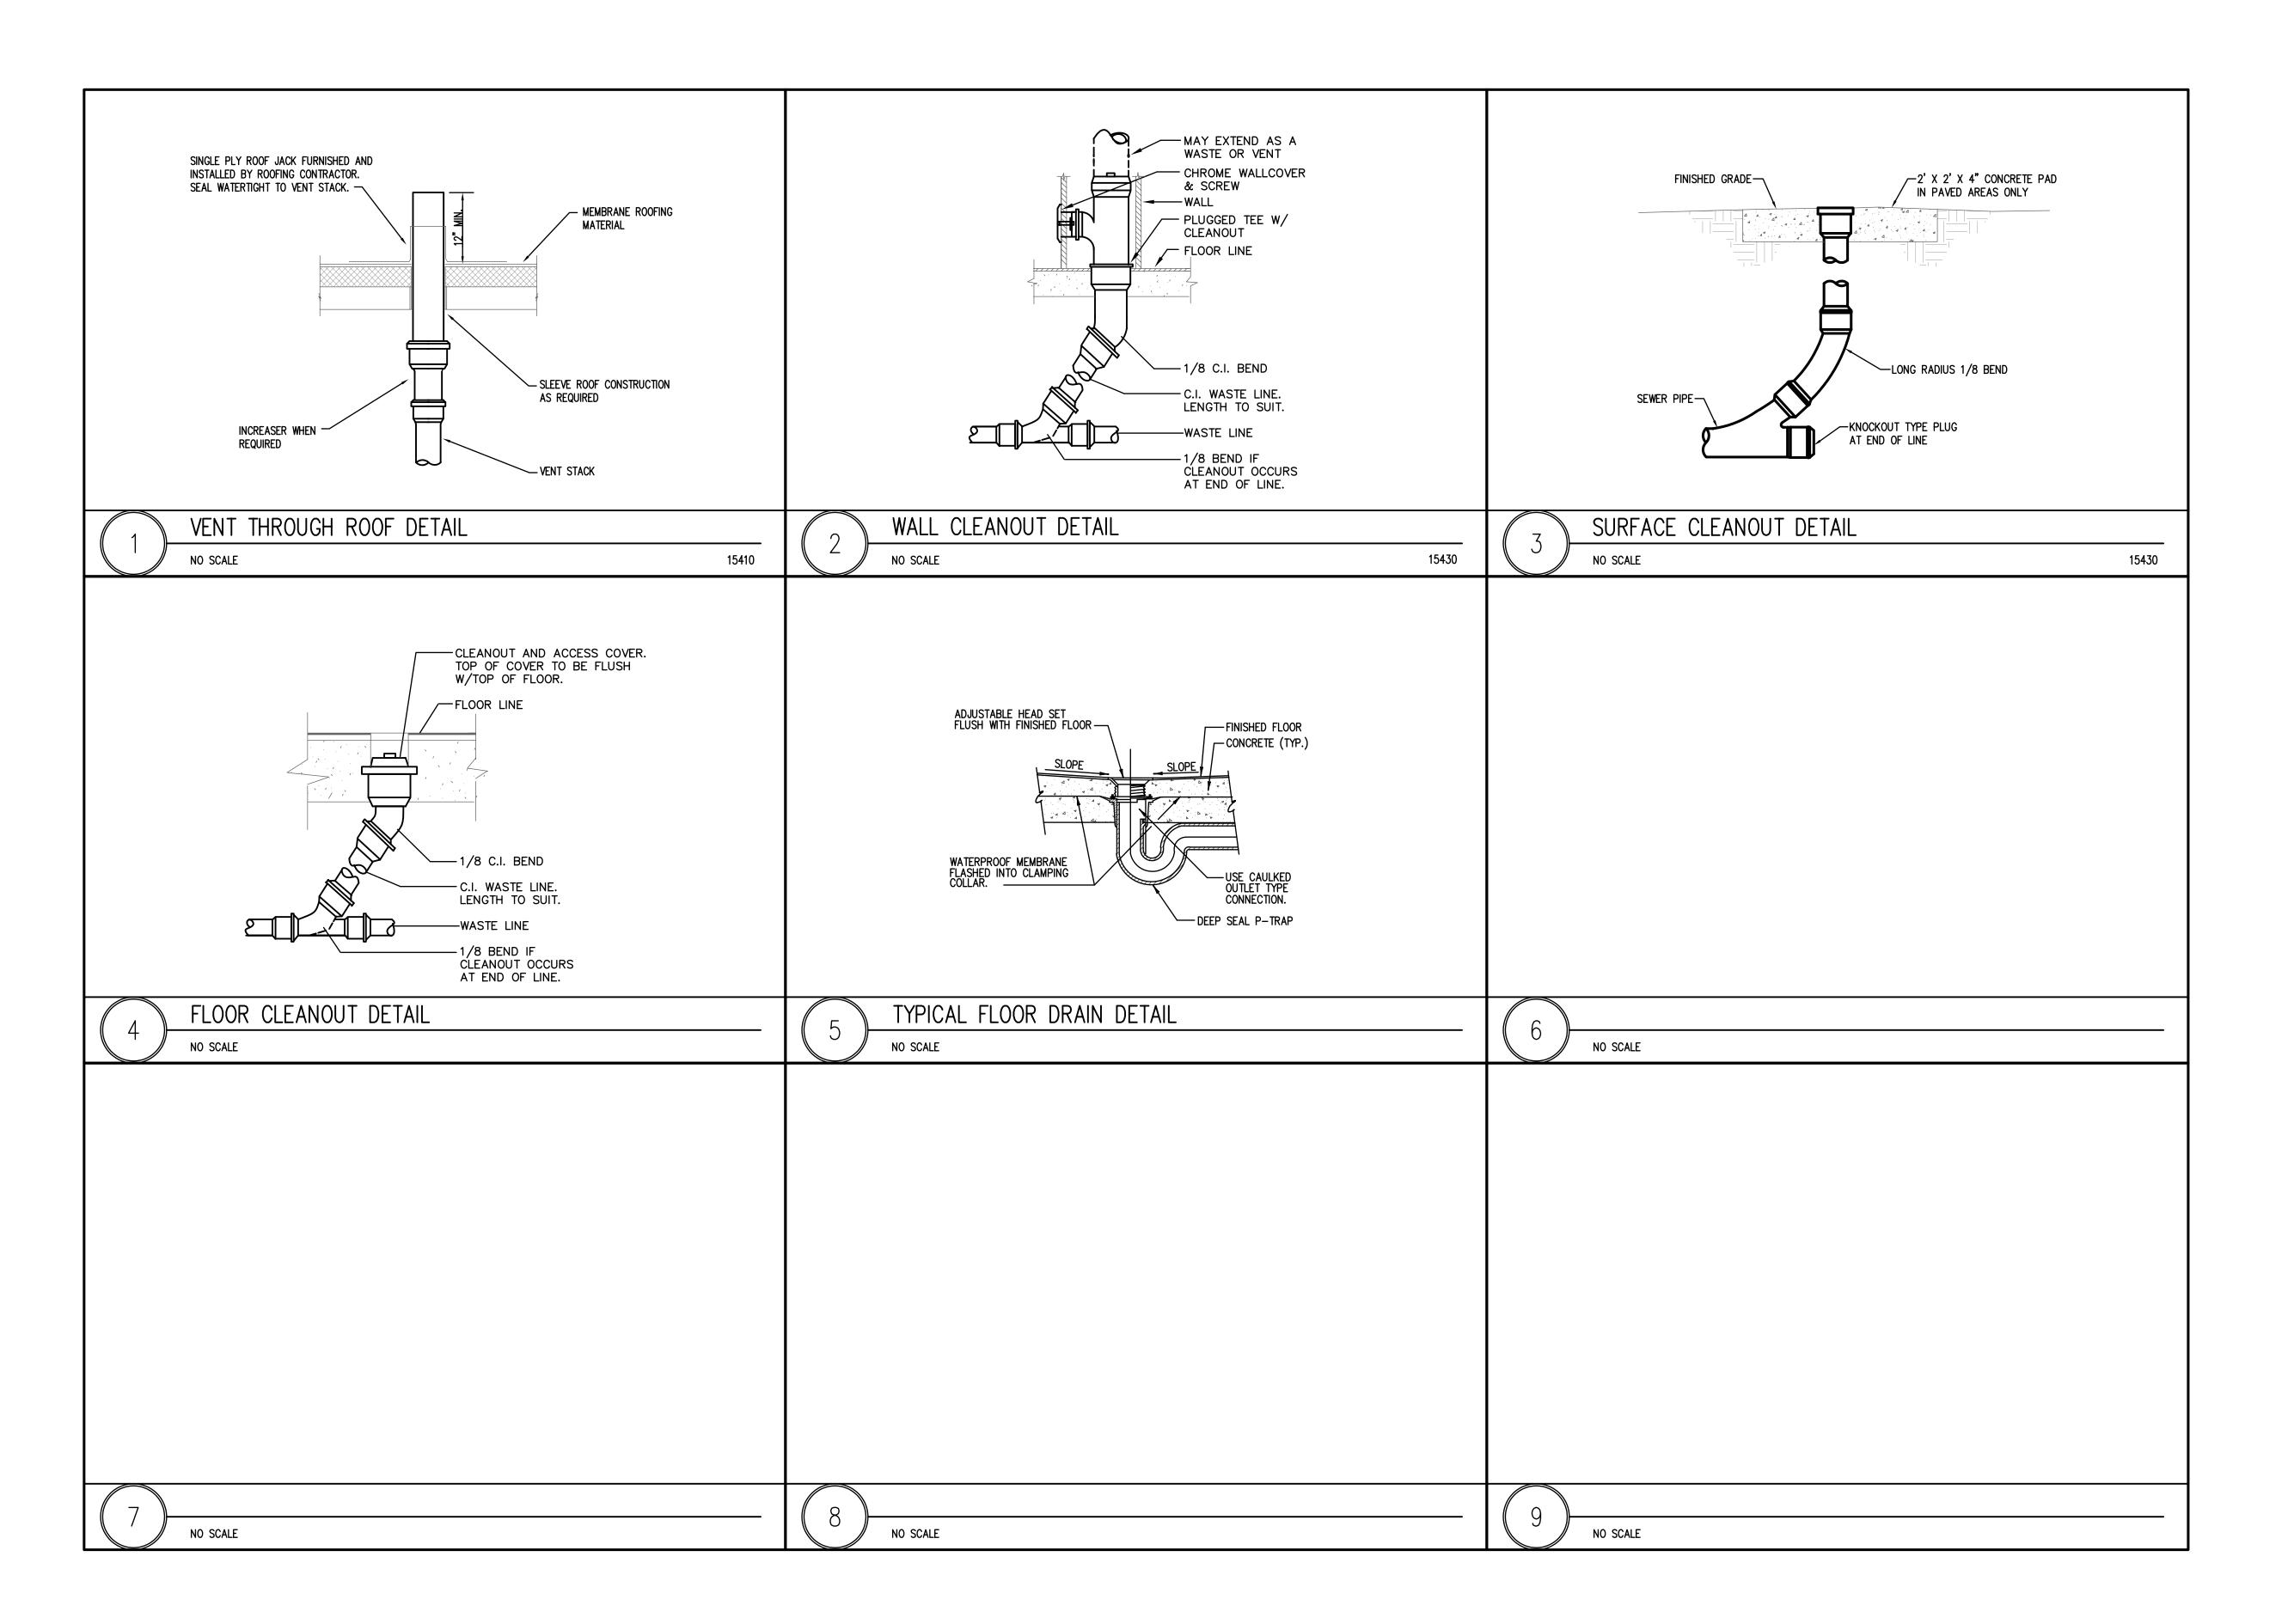
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### SECOND FLOOR PLUMBING REMODEL PLAN

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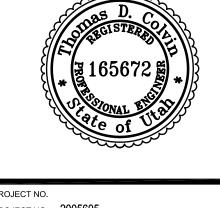






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# LIND LECTURE HALL REMODEL WEBER STATE UNIVERSITY OGDEN CAMPUS OGDEN, UTAH TATE DIVISION OF FACILITIES CONSTRUCTION & MANAGEMENT DFCM PROJECT NO. 04040810



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PLUMBING DETAILS

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					F	PLUMBING	G FIXTUR	E SCHEDULE
PLAN	DECODIDETON			ROUGH-	-IN SIZE			MANUEAGTIDE
CODE	DESCRIPTION	C.W.	H.W.	TEMPERED	WASTE	VENT	STORM	MANUFACTURE
WC-1	WATER CLOSET, ADA COMPLIANT WALL MOUNT, MANUAL FLUSH VALVE, SIPHON JET, VITREOUS CHINA 1.6 GPF	1"	-	-	3"	2"	-	AMERICAN STANDARD "AFWALL" 2257.103 SEAT: OLSONITE #10CC/SS FLUSH VALVE: ZURN Z-6000AV-WS1 COLOR: WHITE FLOOR TO RIM: 17"
WC-2	WATER CLOSET, STANDARD WALL MOUNT, MANUAL FLUSH VALVE, SIPHON JET, VITREOUS CHINA 1.6 GPF	1"	-	-	3"	2"	-	AMERICAN STANDARD "AFWALL" 2257.103 SEAT: OLSONITE #10CC/SS FLUSH VALVE: ZURN Z-6000AV-WS1 COLOR: WHITE FLOOR TO RIM: 15"
U-1	URINAL, ADA COMPLIANT, VITREOUS CHINA, SIPHON JET, BATTERY POWERED PHOTO EYE FLUSH VALVE, 1.0 GPF	3/4"	-	-	2"	1 1/2"	-	AMERICAN STANDARD "WASHBROOK" 6501.010  FLUSH VALVE: ZURN ZEMS-6003AV-WS1 (POWER CONVERTER ZURN# P6000-HP6 BY M.C., POWER UP TO 8 VALVES, SEE PLANS FOR QUANTITY REQUIRED.)  COLOR: WHITE  FLOOR TO RIM: 17"
U-2	URINAL, STANDARD, VITREOUS CHINA, SIPHON JET, BATTERY POWERED PHOTO EYE FLUSH VALVE, 1.0 GPF	3/4"	-	-	2"	1 1/2"	-	AMERICAN STANDARD "WASHBROOK" 6501.010  FLUSH VALVE: ZURN ZEMS-6003AV-WS1 (POWER CONVERTER ZURN# P6000-HP6 BY M.C., POWER UP TO 8 VALVES, SEE PLANS FOR QUANTITY REQUIRED.)  COLOR: WHITE FLOOR TO RIM: 24"
L-1	OVAL, VITREOUS CHINA, COUNTERTOP MOUNTED (ADA) LAVATORY, 4" CENTERSET, CHROME WRISTBLADE HANDLE GOOSENECK FAUCET WITH GRID DRAIN, 0.5 GPM FLOW	1/2"	-	1/2"	1 1/2"	1 1/2"	-	AMERICAN STANDARD "AQUALYN" 0475.020 FAUCET: AMERICAN STANDARD "MONTERREY" 7502.170 P-TRAP ADA INSULATION KIT.
EWC-1	"ADA" SINGLE LEVEL, SURFACE MOUNT ELECTRIC WATER COOLER	3/8"	-	-	1 1/4"	1 1/4"	-	OASIS P8AMSL, BRUSHED STAINLESS STEEL CABINET.
FD-1	FLOOR DRAIN (INDOOR FINISHED AREA USE)	-	-	-	2"	1 1/2"	-	J.R. SMITH MANUFACTURING COMPANY FIG. 2005Y-B-P050-NB DUCO CAST IRON FLOOR DRAIN. DRAIN TO BE PROVIDED WITH 2" OUTLET, SQUARE NICKEL BRONZE STRAINER HEAD, TRAP PRIMER CONNECTION AND VANDAL PROOF SCREWS. STRAINER HEAD MUST BE HEEL PROOF, DEEP SEAL TRAP. OR EQUAL.
WCO	WALL CLEANOUT	-	-	-	-	4"	_	J.R. SMITH MANUFACTURING COMPANY SERIES 4530, CAST IRON CLEANOUT TEE, ABS PLUG, STAINLESS STEEL COVER WITH VANDAL PROOF SECURITY SCREWS. OR EQUAL.
FC0	FLOOR CLEANOUT	I	-	_	_	4"	-	J.R. SMITH MANUFACTURING COMPANY SERIES 4020, CAST IRON ADJUSTABLE BODY, ABS PLUG, VANDAL PROOF SECURITY SCREWS. OR EQUAL.
TP-1	TRAP PRIMER	1/2"	-	-	-	_	-	PRECISION PLUMBING PRODUCTS INC. PR-500. PR-500 WITH DISTRIBUTION SYSTEM DU-2.
HB-1	HOSE BIBB — WALL MOUNTED (INDOOR FINISHED AREA USE)	3/4"	-	-	-	_	-	CHICAGO FAUCETS MODEL 952.CP, BRASS CONSTRUCTION HOSE BIB, CHROME PLATED FINISH, VACUUM BREAKER, 3/4" HOSE THREAD, WALL FLANGE, LOOSE KEY OPERATOR.
SA-1	SHOCK ARRESTOR	1/2"	-	-	_	-	-	PRECISION PLUMBING PRODUCTS SC-500



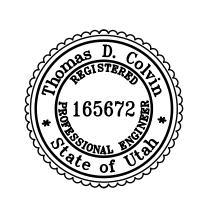


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# LIND LECTURE HALL REMODE WEBER STATE UNIVERSITY OGDEN CAMPUS OGDEN, UT UTAH STATE DIVISION OF FACILITIES CONSTRUCTION & MANAGEMEN DECM PROJECT NO. 04040810

MHTN PROJECT NO.

DFCM PROJECT NO. 2005605



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### PLUMBING SCHEDULES

CD DOCUMENTS DATE 4/20/06

SHEET NUMBER

SYTEOL   DESCRIPTION   LAPS   AFFROVED MANUFACTURERS   CATALOG NUMBER	
HOUNTED FLUSH INTO PLASTER HALL, FIXTURE INSTALLED BY DRYHALL CONTRACTOR AND WIRED BY THE ELECTRICAL CONTRACTOR.    JALL MOUNTED FLUCRESCENT UP 4 DOWN LIGHT FIXTURE WITH PERFORATED FASCIA PLATE. LENGTH AS 940AN ON DRAWINGS.   FORIM   LADA-C-0505-EX-L-WT-2 PRISTA   O71409     T-8   SURFACE MOUNTED 4' FLUCRESCENT STRIP LIGHT FIXTURE WITH WIRE GUARD.   (2) FO32XP T-5     FIXTURE WITH WIRE GUARD.   (2) FO32XP T-5     LIGHT FIXTURE WITH LIGHS STEEL DOOR, 125"   ACRYLIC PRISTATIC LENS, DUAL BALLASTS.   (2) FO32XP T-5     T-4   ARTHUR WIRE FECCESSED CAN LIGHT FIXTURE WITH WRAFARCUND PRISTATIC ACRYLIC LENS.   (2) FO32XP T-5     T-5   WITH FLUCRESCENT FIXTURE WITH CLEAR ALZAK REFLECTOR AND WHITH TRIM RING.   (3) 32 W CFIT WIRE PRISTATIC LENS.   (3) 32 W CFIT WIRE PRISTATIC LENS.   (3) 32 W CFIT WIRE PRISTATIC ACRYLIC LENS.   (3) 42 W CFIT WIRE PRISTATIC AC	
T-2   MALL MOUNTED FLUORESCENT UP & DOWN LIGHT   FIXTURE WITH PERFORATED FASCIA PLATE. LENGTH AS SHOWN ON DRAWINGS.   FOSIXP T-8   FORIM   LADA-C-0505-EX-L-WT-2   FORIM   LITHONIA   C322-WT/OLT-GEBIOPS-WGOUND   FOR TAIL   MITHOLISH   C34-232-EB8PRLHUNY-C5WG-   FOR TAIL   MITHOLISH   C34-232-EB8PRLHUNY-C5WG-   FOR TAIL   MITHOLISH   SECURITY   SECU	
TXTURE WITH PERFORATED FASCIA PLATE. LENGTH AS SHOWN ON DRAWINGS.   FORUM   LADA-C-0505-EX-L-WT-2   LADA-C-0	
T-2   AS SHOWN ON DRAWINGS.   FO32XP   T-8   PRISHA   D744/08   O744/08     SURFACE MOUNTED 4' FLUORESCENT STRIP LIGHT   FIXTURE WITH MIRE GUARD.   FO32XP   T-8   COLUMBIA   C232-HVOLT-GEBIOPS-MGCUI   FO32XP   COLUMBIA   C232-HVOLT-GEBIOPS-MGCUI   COLUMBIA   C24-232-EBBPRLHUNV-CSMG-METALUX   S232-UNV-ER8I-MG/95-4FT-U-A   COLUMBIA   C34-232-UNV-ER8I-MG/95-4FT-U-A   COLUMBIA   C34-232-UNV-ER8I-MG/95-4FT-U-A   COLUMBIA   C34-232-UNV-ER8I-MG/95-4FT-U-A   COLUMBIA   C34-232-UNV-ER8I-MG/95-4FT-U-A   COLUMBIA   C34-232-UNV-ER8I-MG/95-4FT-U-A   C0LUMBIA   C34-232-UNV-ER8I-MG/95-4FT-U-A   C0LUMBIA   S1824-232G-FSAI2.125-120-GEBI   C0LUMBIA   S1824-232G-FSAI2.125-UNV-ER82   C0LUMBIA   C0LUMBIA   S1824-232G-FSAI2.125-UNV-ER82   C0LUMBIA	M-IOTHD*
SURFACE MOUNTED 4' FLUORESCENT STRIP LIGHT   1/2   FO32XP   T-8   EXTAND   FRISTIA   C324-WOLT-GEBIOPS-MGCUN   FIXTURE MITH MIRE GUARD.   C321-BBFRL-HUNV-CSMG-METALUX   S9232-IUNV-ER8H-MG/SG-4FT-U-A   COLUMBIA   C322-EBBFRL-HUNV-CSMG-METALUX   S9232-IUNV-ER8H-MG/SG-4FT-U-A   COLUMBIA   C322-BBFRL-HUNV-CSMG-METALUX   S9232-IUNV-ER8H-MG/SG-4FT-U-A   CITHONIA   C325-BBFRL-HUNV-CSMG-METALUX   C322-IUNV-ER8H-MG/SG-4FT-U-A   CITHONIA   C325-BBFRL-HUNV-CSMG-METALUX   C322-IUNV-ER8H-MG/SG-4FT-U-A   COLUMBIA   C322-IUNV-ER8H-MG/SG-4FT-U-A   COLUMBIA   C322-IUNV-ER8H-MG/SG-4FT-U-A   COLUMBIA   C3232-IUNV-ER8H-MG/SG-4FT-U-A   COLUMBIA   C3232-IUNV-ER8H-MG/SG-4FT-U-A   COLUMBIA   C325-BBFRL-HUNV-CSMG-MG-MG-MG-MG-MG-MG-MG-MG-MG-MG-MG-MG-M	
T-3	
F032XP   T-8	
T-4	
2' X 4' RECESSED GRID MOUNTED FLUORESCENT LIGHT FIXTURE WITH FLUSH STEEL DOOR, 125" ACRYLIC PRISMATIC LENS, DUAL BALLASTS.   F032XP T-8	YC-CHAIN
COLUMBIA   ST824-2326-F5Al2.I25-EB8PR   COLUMBIA   ST824-2326-F5Al2.I25-I20-GEBIO-802A   COLUMBIA   ST824-2326-F5Al2.I25-II0-III-III-III-III-III-III-III-III-II	
T-4   ACRYLIC PRISMATIC LENS, DUAL BALLASTS.   F032XP T-8   METALUX   26C8232A.I25-UNV-ER82   LIGHTOLIER   2P526F5VI232/PSX DUAL   LIGHTOLIER   2P526F5VI232/PSX DUAL   LIGHTOLIER   2P526F5VI232/PSX DUAL   LITHONIA   AA+2-32-2II20-GEBIOPS   COLUMBIA   AA+2-32-EBBPRLHUNV   F1-8   COLUMBIA   AA+2-32-2II20-GEBIO-802A   COLUMBIA   CO	)PS
METALUX   1/3	_HUNV
Y X 4' SURFACE MOUNTED LIGHT FIXTURE WITH WRAPAROUND PRISMATIC ACRYLIC LENS.	
COLUMBIA   AWN4-232-EB8PRLHUNV	
T-5	
METALUX   SAZ3ZA-UNV-ER8	
8" APETURE RECESSED CAN LIGHT FIXTURE WITH CLEAR ALZAK REFLECTOR AND WHITH TRIM RING.   10 32 W CFTT   20-GEBIO-802A   20 PRESCOLITE   CFT832EB-9TF802-B24   PORT-FLUOR   PDT-VI42E-TVC   LIGHTOLIER   8022CCLW-9TI42B   PORT-FLUOR   PDT-VI42E-TVC   LIGHTOLIER   8022CCLW-9TI42B   PORT-FLUOR   PDT-VI42E-TVC   LIGHTOLIER   8022CCLW-9TI42B   PORT-FLUOR   PDT-VI42E-TVC   LIGHTOLIER   20 PR-MI-54T5-120-EB5I   PORT-FLUOR   PDT-VI42E-TVC   LIGHTOLIER   PORT-FLUOR   P	
CLEAR ALZAK REFLECTOR AND WHITH TRIM RING.  (1) 32 W CFTT  PRESCOLITE  PORT-FLUOR  POTI-VI42E-TVC  LIGHTOLIER  8022CCLW-STI42B  4 FEET LONG, SURFACE MOUNTED FLUORESCENT FIXTURE. BASIX PERF MONO.  (1) FO54 T-5 HO  SAME AS T-4 EXCEPT SINGLE BALLAST  (2) FO32XP T-8  METALUX  ST824-232G-FSAI2.125-120-GEBI  COLUMBIA  ST824-232G-FSAI2.125-UNV-ER8I	
T-6	
PORT-FLUOR   PD1-VI42E-TVC	
T-1	
T-1 FIXTURE. BASIX PERF MONO.  (I) FO54 T-5 HO  ZUMTOBEL ZX-RC-WOR-NI/54-4-U-ZX-ZAC-10 EIGHTOLIER  SAME AS T-4 EXCEPT SINGLE BALLAST  (2) FO32XP T-8  METALUX  DXATIFICATION DXATIFICATI	
T-5 HO  T-5 HO  ZUMTOBEL  ZX-RC-WOR-NI/54-4-IJ-ZX-ZAC-10  SF2GJG28-12OAL  SF2GJG28-12OAL  LIGHTOLIER  SF2GJG28-12OAL  LITHONIA  2SP8-G-232-AI2.I25-I2O-GEBI  COLUMBIA  ST824-232G-F9AI2.I25-EB8PR  T-8  METALUX  ZUMTOBEL  ZX-RC-WOR-NI/54-4-IJ-ZX-ZAC-10  SF2GJG28-12OAL  ZUMTOBEL  ZX-RC-WOR-NI/54-4-IJ-ZX-ZAC-10  SF2GJG28-12OAL  ZX-RC-WOR-NI/54-4-IJ-ZX-ZAC-10  SF2GJG28-12OAL  2SP8-G-232-AI2.I25-I2O-GEBI  COLUMBIA  ST824-232G-F9AI2.I25-EB8PR  T-8	
SAME AS T-4 EXCEPT SINGLE BALLAST   LIGHTOLIER   SF2GJG28-I2OAL	
T-8  FO32XP T-8  COLUMBIA  ST824-232G-F9AI2.I25-EB8PR  METALUX  2GC8232A.I25-UNV-ER8I	
T-8 F032XP T-8 COLUMBIA ST824-232G-F9AI2.I25-EB8PR METALUX 2GC8232A.I25-UNV-ER8I	)PS
METALUX 2GC8232A.125-UNV-ER81	_HUNV
LIGHTOLER SP2GFSV1232/PSX	
LED EXIT SIGN WITH DIE CAST WHITE HOUSING, INCLUDED LITHONIA LESWIG 120/277 FLN	
GREEN LETTERS AND BATTERY PACK UNIT.  DUAL-LITE  CVDIGEW	
ISO LITE LPDC-EM-9G-WH-WH-C	
LIGHTOLIER LD9NIGW	
LED EXIT SIGN WITH DIE CAST WHITE HOUSING,	
GREEN LETTERS AND BATTERY PACK UNIT. DOUBLE INCLUDED DUAL-LITE CVD2GEW	
ISO LITE LPDC-EM-DG-WH-WH-C	
LIGHTOLIER LD9NUGW	

NOTES:

I. ALL FLUORESCENT LIGHTS SHALL HAVE ELECTRONIC PROGRAMMABLE START BALLAST'S, 10%, TOTAL HARMONIC DISTORTION.
UNIVERSAL, ADVANCE AND SYLVANIA ARE APPROVED MANUFACTURERS. BALLAST'S TO HAVE 5 YEAR WARRANTY.

- 2. ALL FLUORESCENT LAMPS SHALL HAVE 4100° COLOR TEMPERATURE. PROVIDE PREMIUM T-8 LAMPS AND BALLASTS.
- 3. FIELD VERIFY ALL LIGHTING VOLTAGES PRIOR TO PLACING ANY ORDER.
- 4. THE WRITTEN CRITERIA OF THE FIXTURE DESCRIPTION TAKES PRECEDENCE OVER THE CATALOG NUMBER.

COMN	MUNICATION SYSTEMS SYMBOL LIST
SYMBOL	DESCRIPTION
	TELEPHONE TERMINAL BOARD
	FLUSH TELEPHONE OUTLET
А	INDICATES DEVICE IS ABOVE COUNTER TOP
$\langle x \rangle$	REFERENCE NOTE CALLOUT
FII	RE ALARM SYSTEM SYMBOL LIST
SYMBOL	DESCRIPTION
SD SD	FIRE ALARM PHOTOELECTRIC SMOKE DETECTOR
F	FIRE ALARM MANUAL PULL STATION
H);	FIRE ALARM HORN WITH STROBE HIGH DECIBEL
F.A.C.P.	FIRE ALARM CONTROL PANEL
	IGHTING SYSTEMS SYMBOL LIST
	RECESSED FLUORESCENT FIXTURE
	SURFACE MOUNTED FLUORESCENT FIXTURE
	FLUORESCENT STRIP LIGHT FIXTURE
	RECESSED FIXTURE
	WALL MOUNTED FIXTURE
<b></b>	SURFACE MOUNTED FIXTURE
	WALL SCONCE FIXTURE
E	FIXTURES ON EMERGENCY POWER
$\bigotimes$	EXIT LIGHT. ARROWS SHOW EXIT DIRECTION
<u> </u>	TRACK LIGHTING FIXTURE
\$	SINGLE POLE TOGGLE SWITCH - 20 AMP
<b>\$</b> a,b	SINGLE POLE TOGGLE SWITCH - 20 AMP, LETTERS INDICATE SWITCH ASSIGNMENT
\$3	THREE WAY TOGGLE SWITCH - 20 AMP
U,I,DT	CEILING MOUNTED OCCUPANCY SENSOR - U = ULTRASONIC, I = INFRARED, DT = DUAL TECH.
ØM∆U,I,DT	WALL MOUNTED OCCUPANCY SENSOR - U = ULTRASONIC, I = INFRARED, DT = DUAL TECH.
D	SLIDE CONTROL DIMMER
(T-X)	LIGHTING FIXTURE CALLOUT. NUMBER INDICATES A SUGGESTED QUANTITY- TO BE VERIFIED
	POWER SYSTEMS SYMBOL LIST
SYMBOL	DESCRIPTION
Φ	DUPLEX CONVENIENCE OUTLET - 20 AMP
	DUPLEX CONVENIENCE OUTLET - 20 AMP GROUND FAULT INTERRUPTER
<b>+</b>	4-PLEX CONVENIENCE OUTLET - 20 AMP
	JUNCTION BOX - SIZE AND FUNCTION AS REQUIRED
-#-	CONDUITS CONCEALED IN FLOOR OR BELOW GRADE
	CONDUITS CONCEALED IN CEILING AND WALLS
	ARROWS INDICATE HOME RUNS - LINES INDICATE NUMBER CONDUCTORS
<u> </u>	NON FUSED DISCONNECT SWITCH - SIZE AS REQUIRED
	FUSED DISCONNECT SWITCH - SIZE AS REQUIRED
	COMBINATION STARTER DISCONNECT
<b>(5)</b>	MOTOR LOCATION
\$1	MANUAL DISCONNECT WITH THERMAL OVERLOAD PROTECTION
Ψ'	
	ELECTRICAL PANEL LOCATION
CLG	INDICATES CEILING MOUNTED DEVICE
[XX-I]	MECHANICAL EQUIPMENT CALLOUT

	MECHANIC	AL E	QUIF	MEN	T SC	CHED	ULE		
	NAME OF MECHANICAL EQUIPMENT	IN-LINE EXHAUST FAN	IN-LINE EXHAUST FAN	FAN COIL UNIT	HEAT PUMP UNIT	ENERGEY RECOVERY UNIT	I	I	1
	EQUIPMENT NO.	EF-I	EF-2	FC-I	CU-I	ERU-I			
	RATING/WATTS	3/4 HP	1/2 HP	15 KW		2 HP			
	VOLTAGE	208	120	208	208	208			
	PHASE	3	ı	3	3	3			
	AMPS	3.22	9.8	70.8	15.7	15.8			
DATA	WIRE SIZE	3 #12	2 #12	3 #4	3 #12	3 #12			
	GROUND WIRE	l #l2	l #l2	I #8	l #l2	l #l2			
MOTOR	CONDUIT SIZE	3/4"	3/4"	l"	3/4"	3/4"			
	FUSE DISC. SW.	30		100	30	30			
	TYPE RKI FUSES	4.5		80	20	20			
	NON-FUSE SW.								
Ī	CAPACITOR (KVAR)								
	NOTES	3	2	3		3			

- I. STARTER IS FURNISHED WITH THE UNIT. PROVIDE SITE DISCONNECT.

  2. PROVIDE THERMAL OVERLOAD SWITCH.
- PROVIDE COMBINATION STARTER & DISCONNECT (HOA) W/ (2) N.O. & N.C. CONTACTS.
   UNIT FURNISHED WITH VFD. PROVIDE SITE FUSED DISCONNECT WITH ELECTRICAL INTERLOCK (FACTORY) INSTALLED.

**GENERAL NOTES:** 

THE OUTLETS.

- 1) REFER TO THE ARCHITECTURAL REFLECTED CEILING PLANS FOR THE EXACT LOCATION OF ALL LIGHTING FIXTURES.
- ② MINIMUM SIZE OF CONDUIT TO BE 3/4". ALUMINUM CONDUITS SHALL NOT BE USED.
- ③ USE RIGID STEEL SET SCREW TYPE FITTINGS ONLY. DIE CAST FITTINGS SHALL NOT BE USED.
- 4 SUPPORT THE LAY-IN TYPE FIXTURES FROM THE CEILING DECK INDEPENDENT OF THE CEILING GRID, AS SHOWN ON THE TYPICAL RECESSED FIXTURE MOUNTING DETAIL.
- (5) ALL NEW WORK MUST MEET THE CURRENT NATIONAL ELECTRICAL CODE (2005).
- 6 NOT MORE THAN THREE (3) CIRCUITS, SHALL BE INSTALLED IN A 3/4" CONDUIT.

  (7) THE SIZE OF THE NEUTRAL CONDUCTORS SHALL BE NO. 10 AWG FOR ALL HOME
- (8) THE MINIMUM SIZE OF THE CONDUCTORS ARE TO BE #12 AWG THHN COPPER, UNLESS INDICATED OTHERWISE ON THE DRAWINGS.

RUNS WITH COMMON NEUTRAL (LIGHTING AND POWER CIRCUITS).

- 9 ALL J-BOXES SHALL BE 4"X4" WITH A MINIMUM DEPTH OF 2-1/8" UNLESS OTHERWISE SPECIFIED. SECURE ALL J-BOXES AS SHOWN IN THE DETAILS. FURNISH AND INSTALL PROPER MUD RINGS.
- 10 ALL NEW EXPOSED CONDUIT MUST RUN AGAINST THE WALLS OR CEILINGS. DO NOT PENDANT MOUNT ANY CONDUIT FROM THE CEILINGS.
- (1) USE NO. 10 THHN CONDUCTORS FOR HOMERUNS OVER 100 FEET, NO. 8 THHN OVER 200 FEET, NO. 6 THHN OVER 300 FEET AND NO. 4 THHN OVER 400 FEET
- PAINT ALL THE J-BOXES FOR FIRE ALARM SYSTEM WITH RED PAINT. MARK ALL THE CONDUIT FOR FIRE ALARM SYSTEM EVERY 8' WITH RED STRIPE. DO NOT PAINT SURFACE WIREMOUD.
- PAINT SURFACE WIREMOLD.

  (3) COORDINATE WITH THE OWNER AND ARCHITECT FOR THE EXACT LOCATION OF
- (14) LIGHT SWITCHES INSTALLED ADJACENT TO EACH OTHER, SHALL BE GANGED TOGETHER WITH ONE PIECE COVERPLATE.
- (5) AT THE END OF THE JOB, PROVIDE BLANK COVER PLATES TO MATCH THE OTHER COVER PLATES FOR ALL J-BOXES WHERE DEVICES HAVE NOT YET BEEN
- (16) SEAL AROUND ALL CONDUIT PENETRATIONS THROUGH WALLS AND CEILINGS WITH FIRE RATED MATERIAL. 3M IS AN APPROVED MANUFACTURER.
- (7) ALL MATERIALS USED IN THIS INSTALLATION SHALL BE U.L. APPROVED AND NEW.
- (18) ALL ELECTRICAL WIRING MUST BE IN CONDUIT (ROMEX AND MC CABLES ARE NOT PERMITTED).
- PRIOR TO SUBMITTING A BID THE ELECTRICAL CONTRACTOR SHALL INSPECT THE SITE AND INCLUDE IN HIS BID PACKAGE ALL CHARGES DUE TO EXISTING CONDITIONS. SHOP DRAWINGS ARE REQUIRED.
- ② ALL DUPLEX OUTLETS AND SWITCHES SHALL BE 20 AMP., 120 VOLT SPEC GRADE DECOR TYPE. HUBBELL AND PASS & SEYMOUR AND LEVITON ARE APPROVED MANUFACTURERS.
- (2) THE ELECTRICAL CONTRACTOR SHALL NOTIFY AND COORDINATE WITH THE MECHANICAL CONTRACTOR SO THAT NO PIPING, DUCTS, OR OTHER EQUIPMENT SHALL BE INSTALLED IN ENTRY OR PASS THROUGH ELECTRICAL ROOM OR SPACES ABOVE OR BELOW ELECTRICAL PANELS.
- 22 ELECTRICAL CONTRACTOR SHALL VERIFY ALL ELECTRICAL LOADS (VOLTAGE, PHASE, CONNECTION REQUIREMENT, ETC.) OF EQUIPMENT FURNISHED UNDER OTHER DIVISIONS WITH APPROVED SHOP DRAWINGS.
- THE CONTRACTOR SHALL INFORM THE ARCHITECT/ENGINEER IN WRITING OF ANY DISCREPANCIES FOUND BETWEEN THE INTENDED FUNCTION OF EQUIPMENT AND EQUIPMENT SPECIFIED IN THE CONTRACT DOCUMENTS A MINIMUM OF FIVE (5) WORKING DAYS PRIOR TO ISSUANCE OF THE FINAL ADDENDUM. FAILURE TO REPORT ANY DISCREPANCY (CATALOG NUMBERS, DISCONTINUED ITEMS, ETC.) DOES NOT RELIEVE THE CONTRACTOR FROM PROVIDING EQUIPMENT WHICH SHALL CONFORM TO AND FULFILL THE INTENT OF THE CONTRACT DOCUMENTS. NOR SHALL IT BE USED AS A CONDITION TO OBTAIN ADDITIONAL FUNDS FROM THE OWNER AFTER THE CONTRACT IS AWARDED. THE CONTRACTOR SHALL REQUEST ALL CLARIFICATIONS OF CONTRACT DOCUMENT REQUIREMENTS IN WRITING TO THE ARCHITECT/ENGINEER A MINIMUM OF FIVE WORKING DAYS PRIOR TO ISSUANCE OF THE FINAL ADDENDUM.
- PROVIDE TYPED LABEL FOR ALL NEW DUPLEX OUTLETS AND NEW LIGHT SWITCHES TO INDICATE WHICH CIRCUIT AND PANELBOARD THEY ARE TIED TO.
- (3) INSTALL EXIT SIGNS ON THE WALL IF POSSIBLE.
- 26 PROVIDE UPDATED TYPED WRITTEN PANEL SCHEDULE FOR ALL EXISTING PANELBOARDS WHERE CIRCUITS HAVE BEEN ADDED OR REMOVED.
- ALL NEW CONDUIT MUST BE CONCEALED IN WALLS. REVIEWING ROUTING OF ANY NEW CONDUIT WHICH ABSOLUTELY CAN NOT BE CONCEALED WITH ENGINEER OR ARCHITECT PRIOR TO ROUGH IN. ALL EXPOSED RACEWAY MUST BE WIREMOLD WITH WIREMOLD SURFACE MOUNTED SHALLOW BOX. ALL EXPOSED RACEWAYS MUST BE PAINTED PRIOR TO INSTALLATION TO MATCH AS CLOSE AS POSSIBLE THE COLOR OF EXISTING SURFACE. SUCH AS IN POOL AREA AND GYMNASIUM.
- 28 LOCATION OF ALL CORE DRILLING FOR CONDUIT BETWEEN FLOORS AND THROUGH EXISTING CONCRETE WALLS MUST BE COORDINATED WITH GENERAL CONTRACTOR AHEAD OF TIME.
- (2) PROVIDE ENGRAVED NAME TAG FOR ALL NEW DISCONNECT SWITCHES TO INDICATE NAME OF DEVICE, CIRCUIT AND PANEL FEEDING DEVICE.



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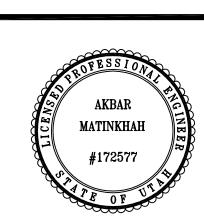
www.mhtn.com

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### NIVERSITY OGDEN, UTAH

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UTAH STATE DIVISION OF FACILITIES CONSTRUCTION DFCM PROJECT NO. 040408



MHTN PROJECT NO.		2005605	302	
DRAWI	N BY: JHM	C		
ISSUE	):			
NO.	DATE	DESCRI	PTION	
1	3.24.06	BID PAC	CKAGE #1	
2	4.20.06	BID PAC	CKAGE #2	

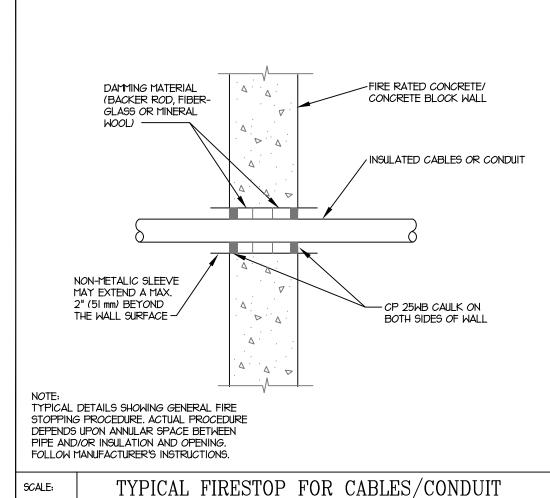
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GENERAL NOTES & SCHEDULES

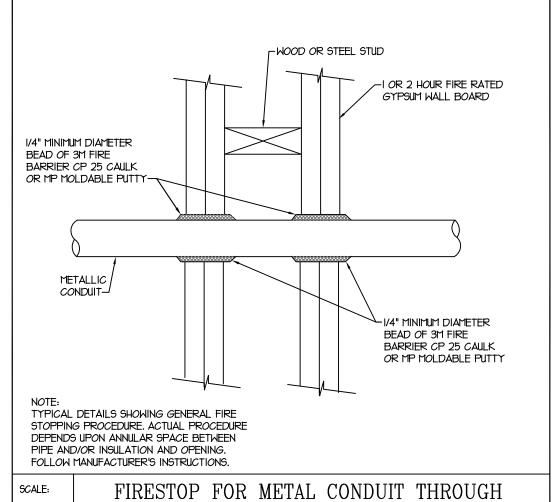
CONSTRUCTION DOCUMENTS

SHEET NUMBER

EE001

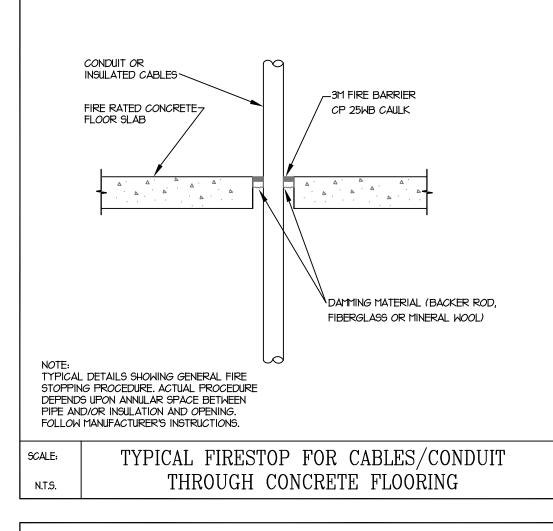


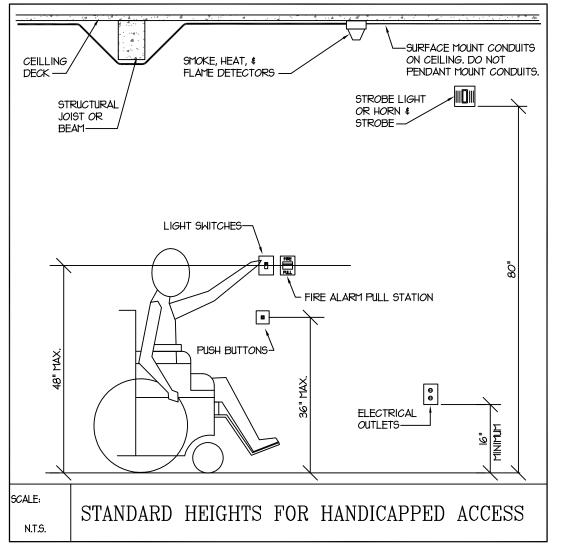


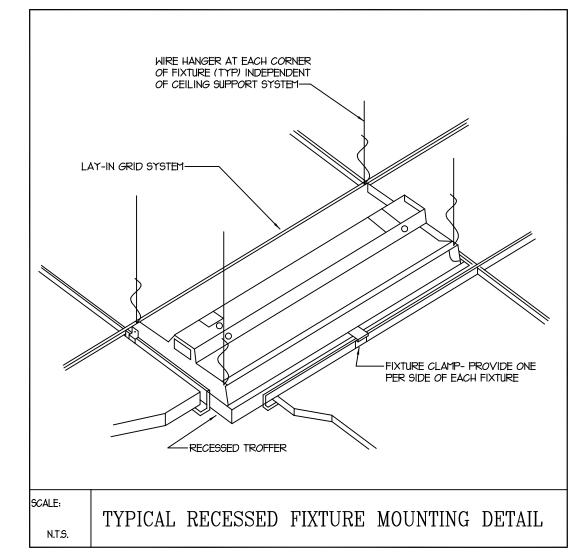


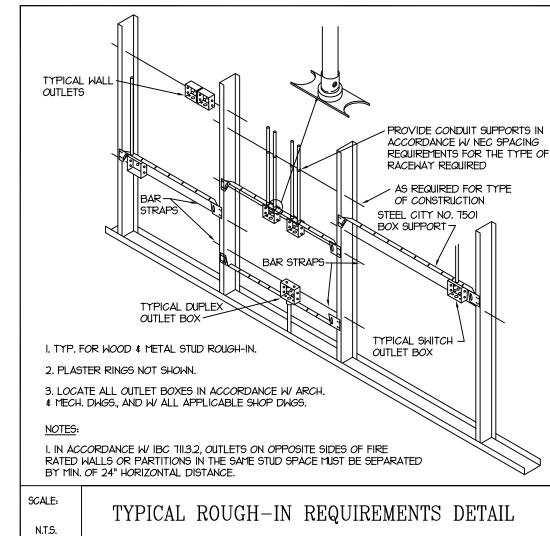
GYPSUM WALL BOARD

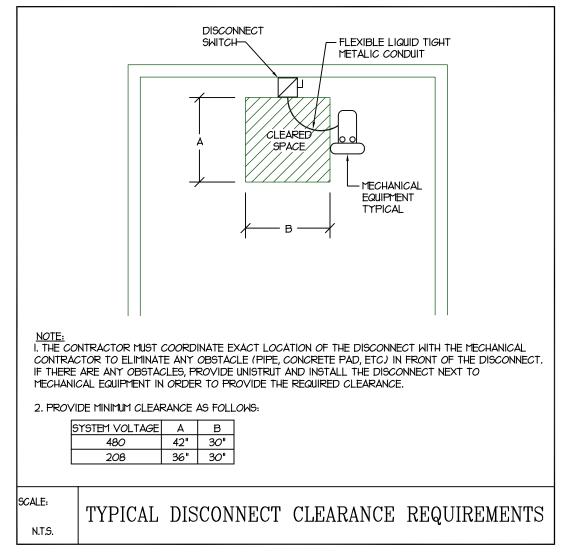
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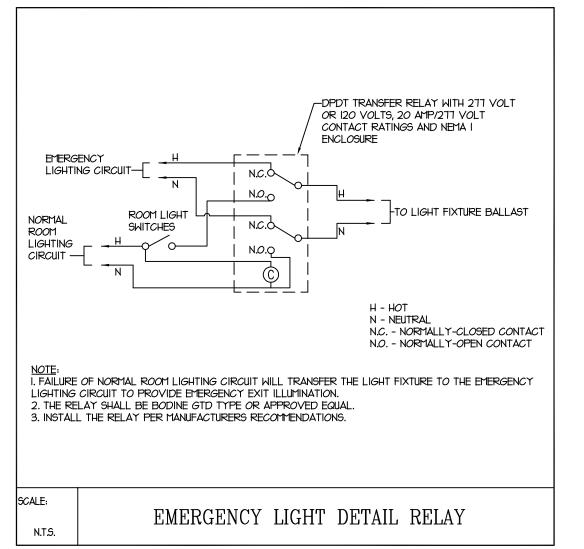


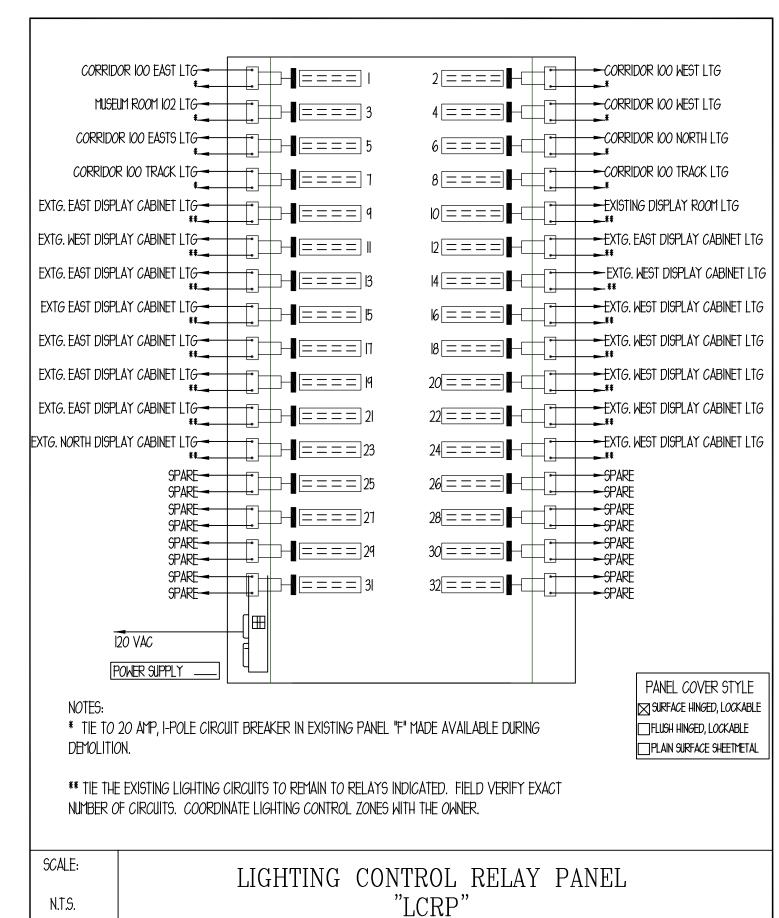


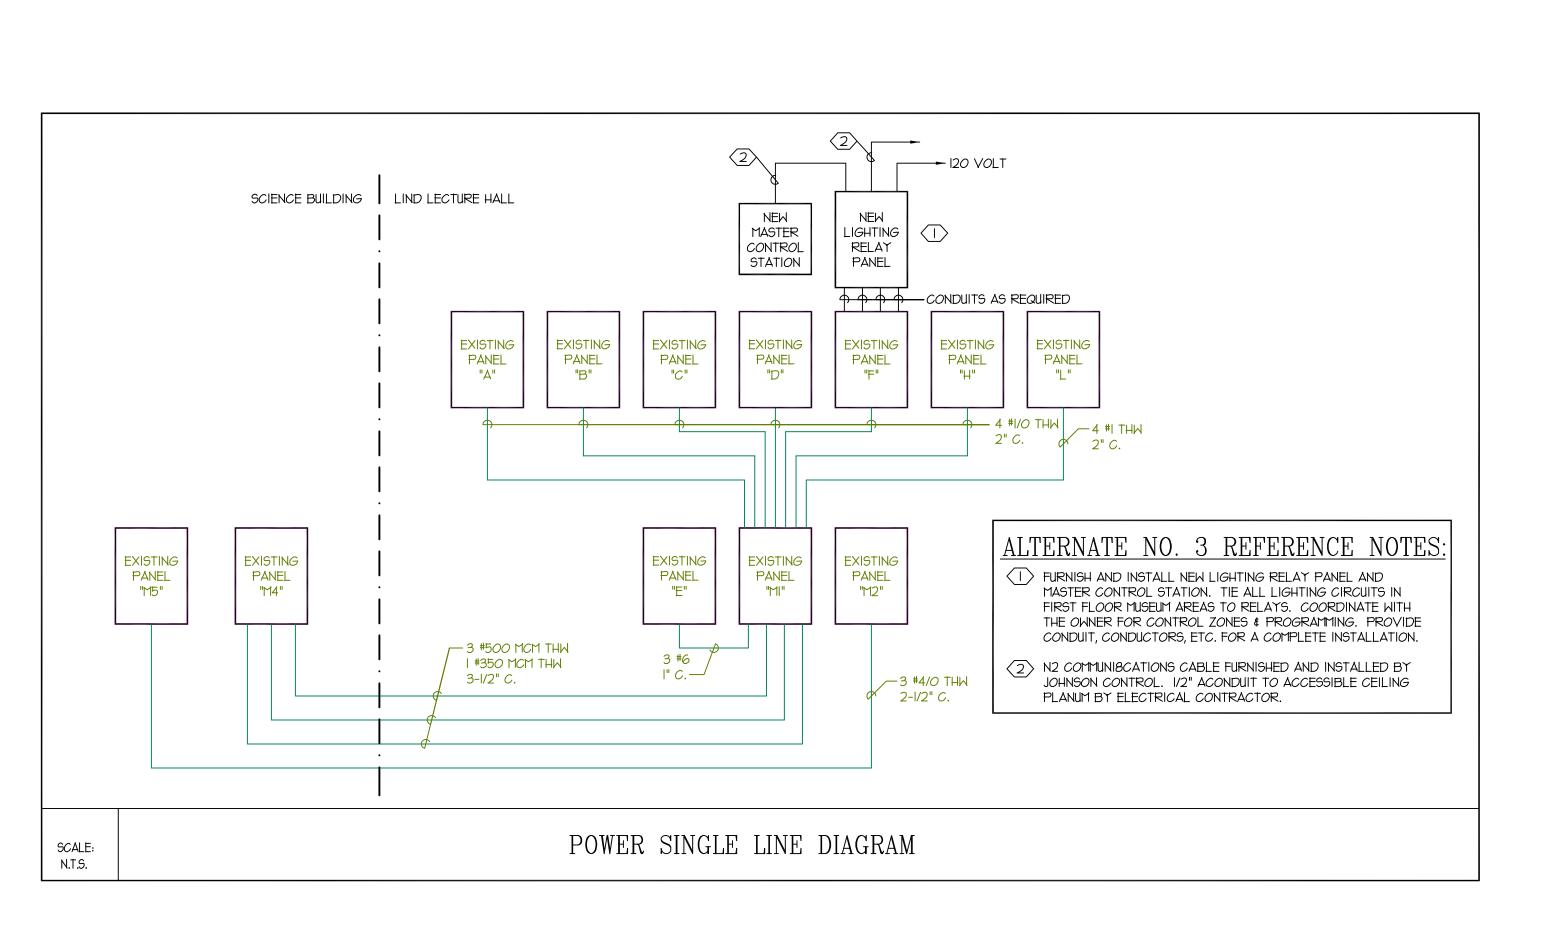














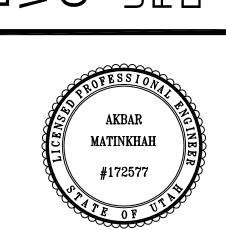
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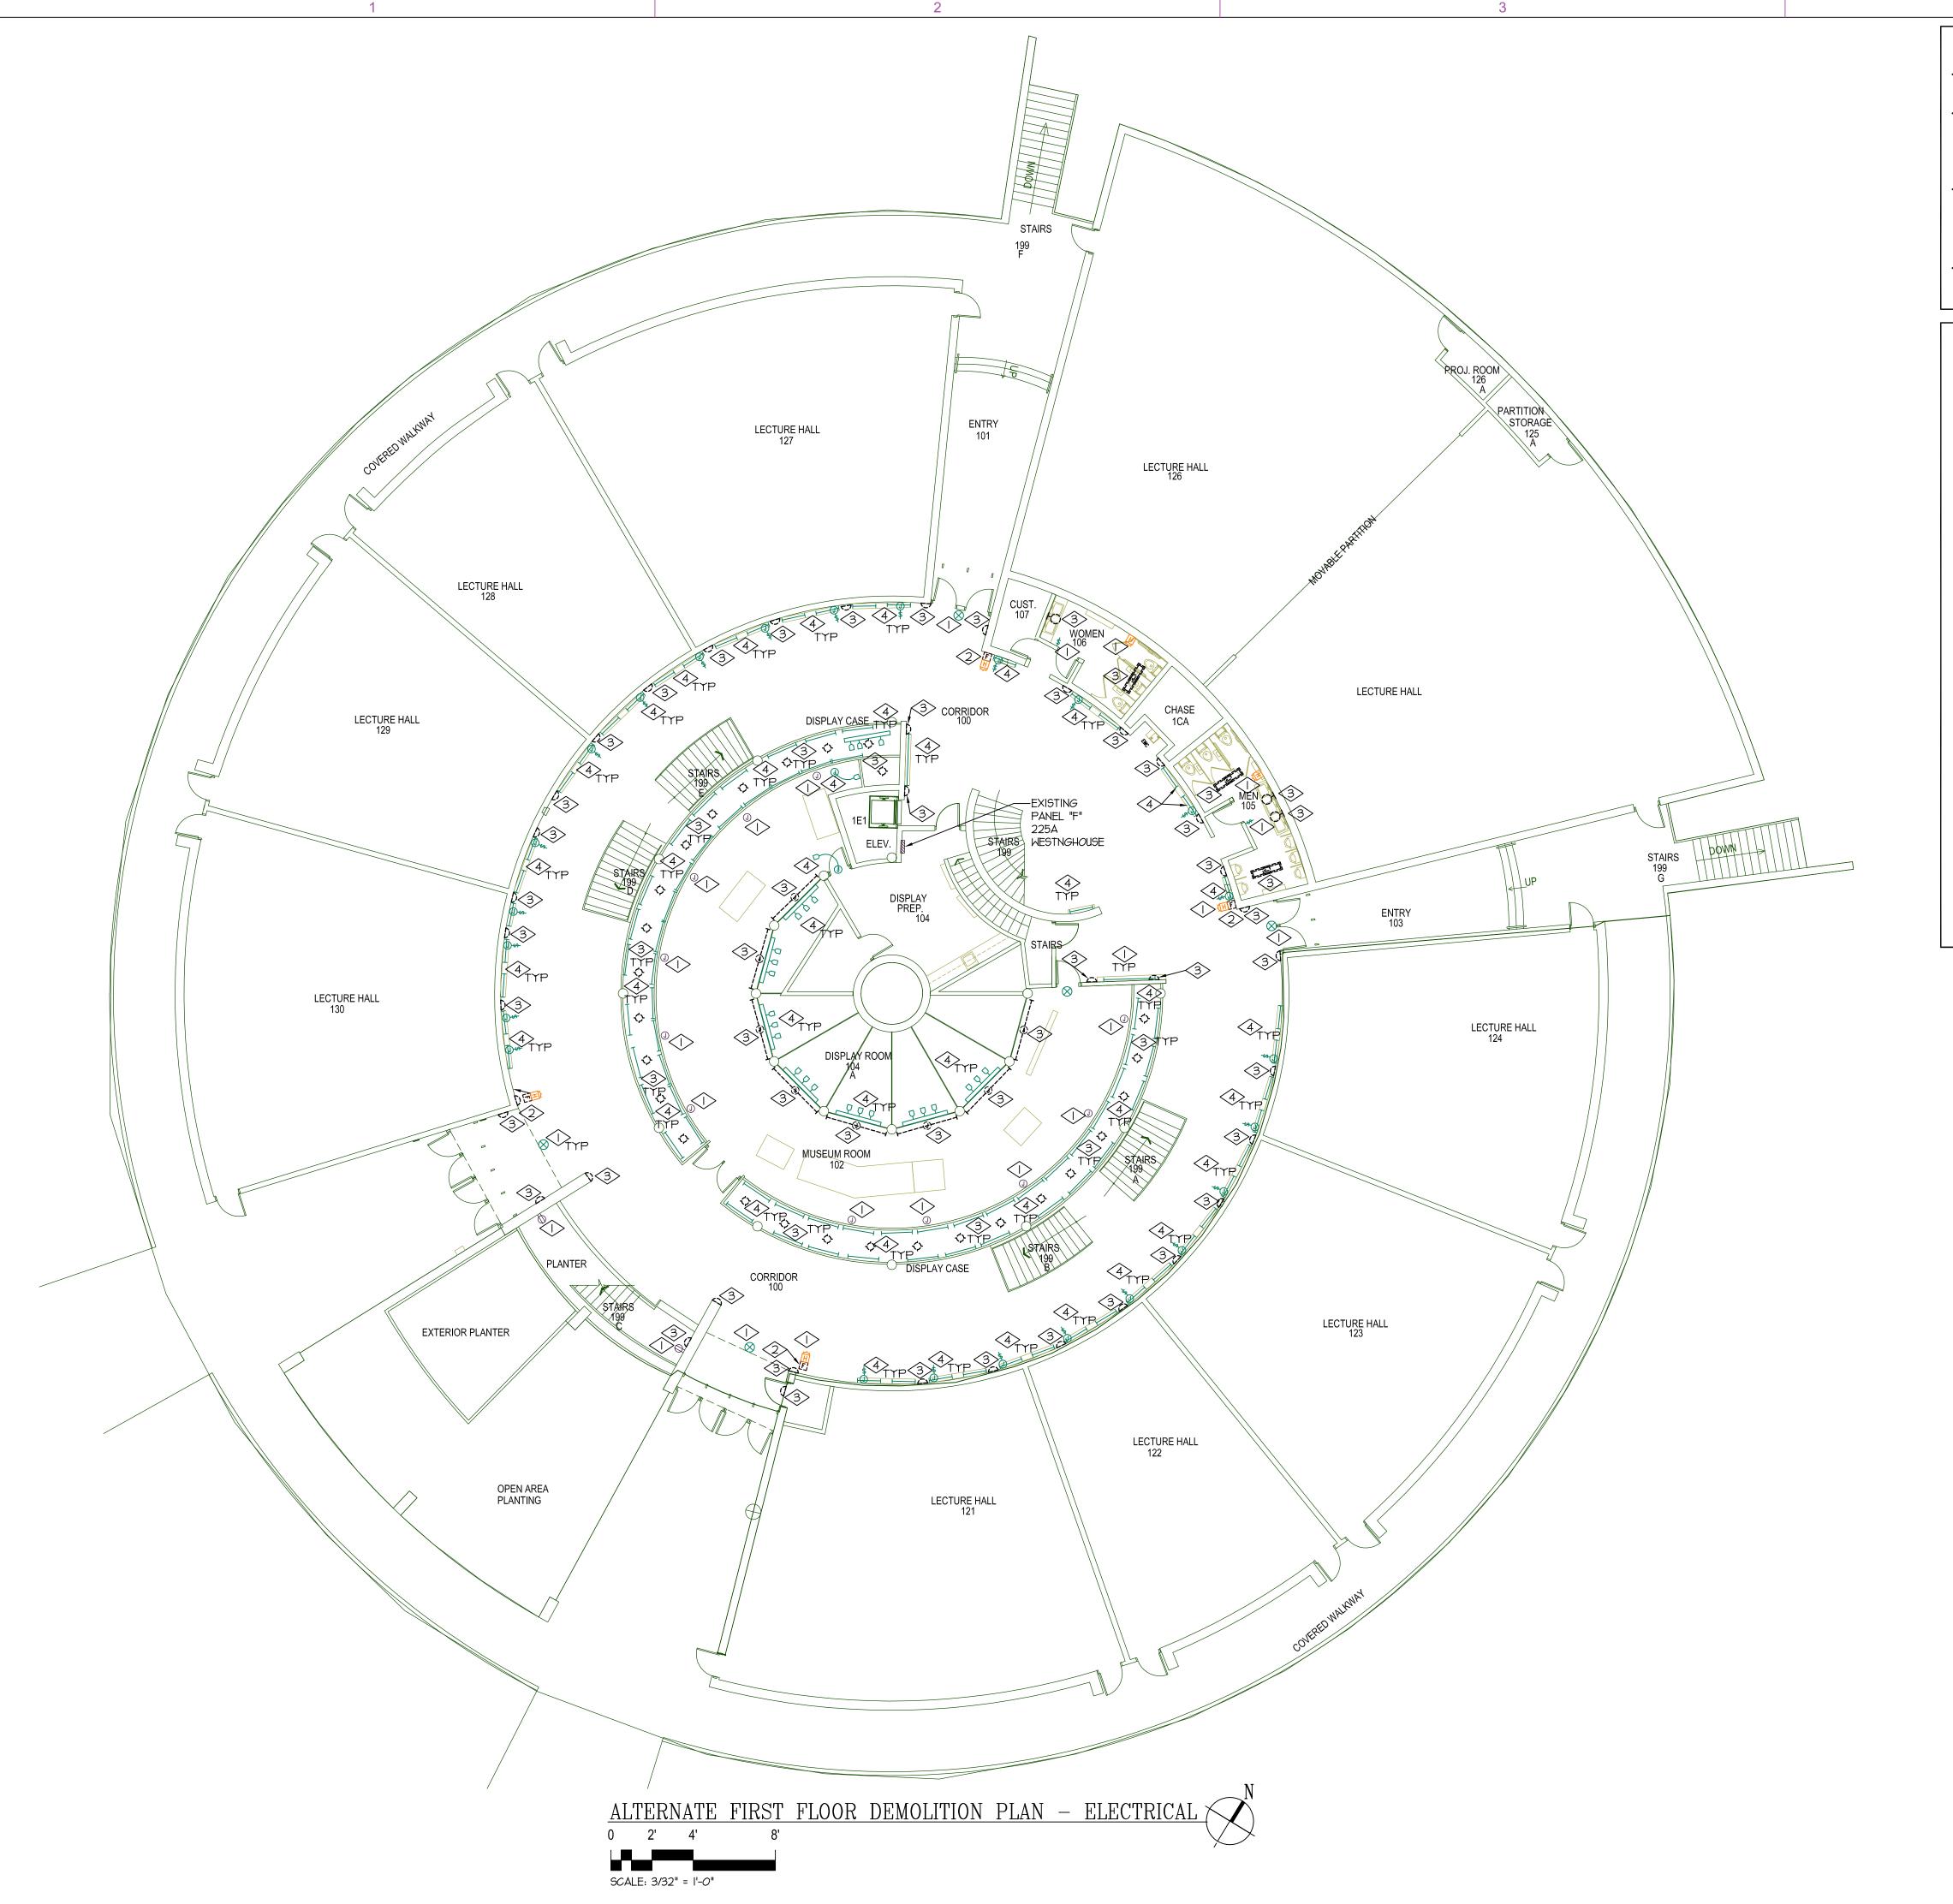
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NO.	DATE	DESCRIPTION
1	3.24.06	BID PACKAGE #1
2	4.20.06	BID PACKAGE #2
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REVISIO	ONS:	
REVISIONO.	ONS:	DESCRIPTION
		DESCRIPTION

POWER SINGLE LINE DIAGRAM & DETAILS

CONSTRUCTION DOCUMENTS

SHEET NUMBER

**EE002** 



- EXISTING DEVICES SHALL REMAIN. MAKE ANY MODIFICATIONS REQUIRED TO MAINTAIN CIRCUIT INTEGRITY.
- REMOVE THE EXISTING FIRE ALARM MANUAL PULL STATION AND REINSTALL AT 48" A.F.F. TRACE CIRCUIT BACK TO NEAREST REMAINING DEVICES AND FROM THERE EXTEND CONDUCTORS AND CONDUIT TO THE NEW LOCATION. DO NOT SPLICE FIRE ALARM CONDUCTORS.
- REMOVE THE EXISTING LIGHT FIXTURES INDICATED. REMOVE CONDUCTORS ALL THE WAY BACK TO ORIGINATION POINT. UTILIZE EXISTING CONDUIT AND J-BOXES AS POSSIBLE FOR NEW INSTALLATION. REMOVE ANY ABANDONED CONDUIT. COORDINATE WORK WITH GENERAL CONTRACTOR.
- RE-CIRCUIT THE EXISTING DISPLAY LIGHT FIXTURES THROUGH THE NEW LIGHTING RELAY PANEL. REFER TO SHEET ELIOI-ALT FOR MORE INFORMATION.

### **GENERAL DEMOLITION NOTES:**

I. AT THE END OF THE DEMOLITION PROJECT ELECTRICAL CONTRACTOR IS TO UPDATE PANEL IDENTIFICATION CARD FOR ALL THE PANELBOARDS WHICH HAVE HAD CIRCUITS MODIFIED UNDER THIS CONTRACT.

2. ELECTRICAL CONTRACTOR IS TO PROVIDE TEMPORARY LIGHTING AND POWER FOR OTHER TRADES DURING DEMOLITION WORK. UTILIZE EXISTING PANELBOARDS WHICH ARE TO REMAIN. COORDINATE THIS WORK WITH THE GENERAL CONTRACTOR.

3. ELECTRICAL CONTRACTOR IS TO REMOVE ALL ELECTRICAL CONNECTIONS AND CONTROL WIRING TO ALL THE EXISTING MECHANICAL EQUIPMENT IN THE REMODEL AREA, ETC. REMOVE ALL CONDUIT AND CONDUCTORS ALL THE WAY BACK TO PANELBOARDS. COORDINATE THIS WORK WITH MECHANICAL CONTRACTOR.

4. ELECTRICAL CONTRACTOR IS TO MAINTAIN POWER TO ALL DEVICES, EQUIPMENT, LIGHTS, ETC. IN OTHER PART OF THE BUILDING. TRACE ALL THESE CIRCUITS AND PROPERLY IDENTIFY IN PANEL SCHEDULES. COORDINATE THIS WORK WITH GENERAL CONTRACTOR AND CAMPUS ELECTRICAL SHOP.

5. ALL MATERIALS TO BE REMOVED FROM THE PREMISES BY THE CONTRACTOR.

6. IN AREAS WHERE CIRCUIT CONTINUITY IS INTERRUPTED TO THE DEVICES WHICH ARE TO REMAIN MAKE ALL THE NECESSARY MODIFICATIONS TO THE CIRCUITS IN ORDER TO MAINTAIN THE CIRCUIT INTEGRITY IN THE SAME DAY.

7. ALL NEW WORK MUST MEET THE CURRENT NATIONAL ELECTRICAL CODE.

8. PRIOR TO SUBMITTING A BID THE ELECTRICAL CONTRACTOR SHALL INSPECT THE SITE AND INCLUDED IN HIS BID PACKAGE ALL CHARGES DUE TO EXISTING CONDITIONS.

9. ALL ABANDONED CONDUIT IN CONCRETE SLABS OR WALLS MUST BE CUT OFF AFTER CONDUCTORS HAVE BEEN REMOVED AND GROUND FLUSH WITH ADJACENT SURFACES. PATCH AND PAINT WALL AND SLABS TO MATCH. COORDINATE THIS WORK WITH THE GENERAL CONTRACTOR. PROVIDE BLANK COVERPLATES FOR J-BOXES IN CONCRETE OR BLOCK WALLS WHICH ARE NOT BEING USED.



MHTN ARCHITECTS, INC.

420 East South Temple Suite 100 Salt Lake City, Utah 84111 Telephone (801) 595-6700

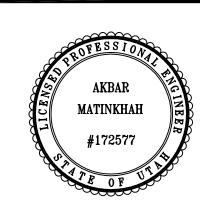


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### OGDEN, UTAH

LIND LECTURE HAI WEBER STATE UNI OGDEN CAMPUS

UTAH STATE DIVISION OF FACILITIES CONSTRUCTION DECM PROJECT NO. 04040



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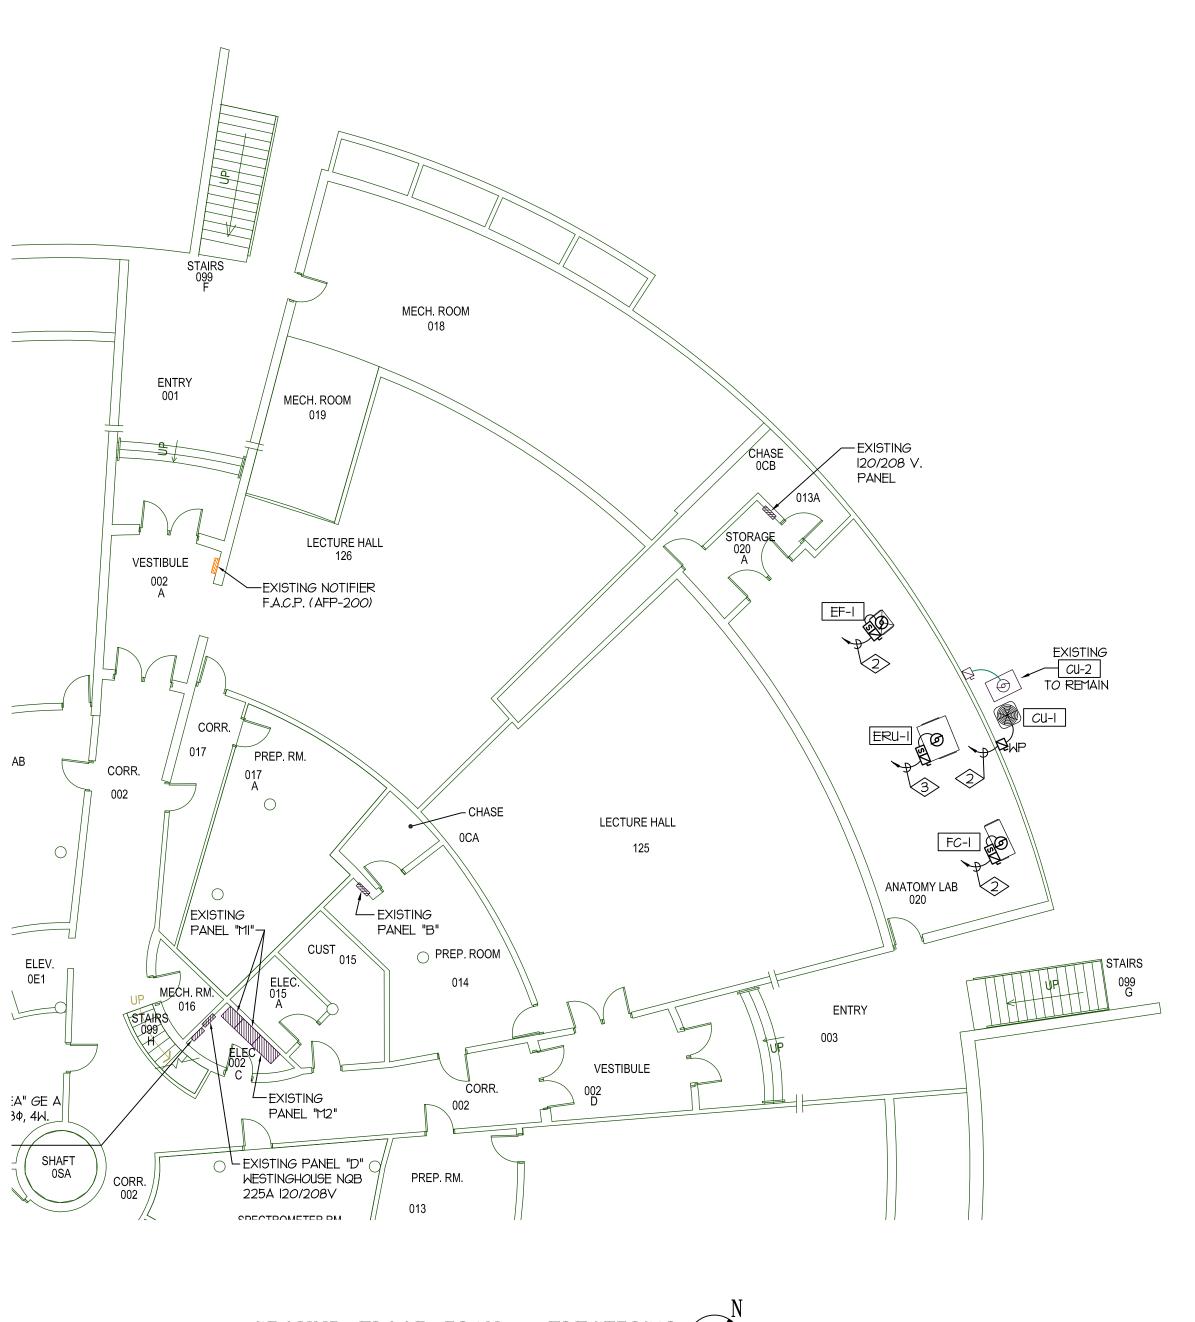
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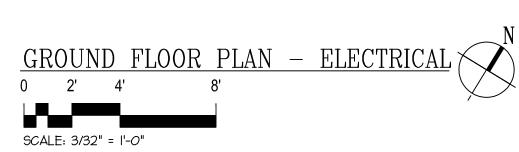
ALT. FIRST FLOOR DEMOLITION PLAN ELECTRICAL

CONSTRUCTION DOCUMENTS

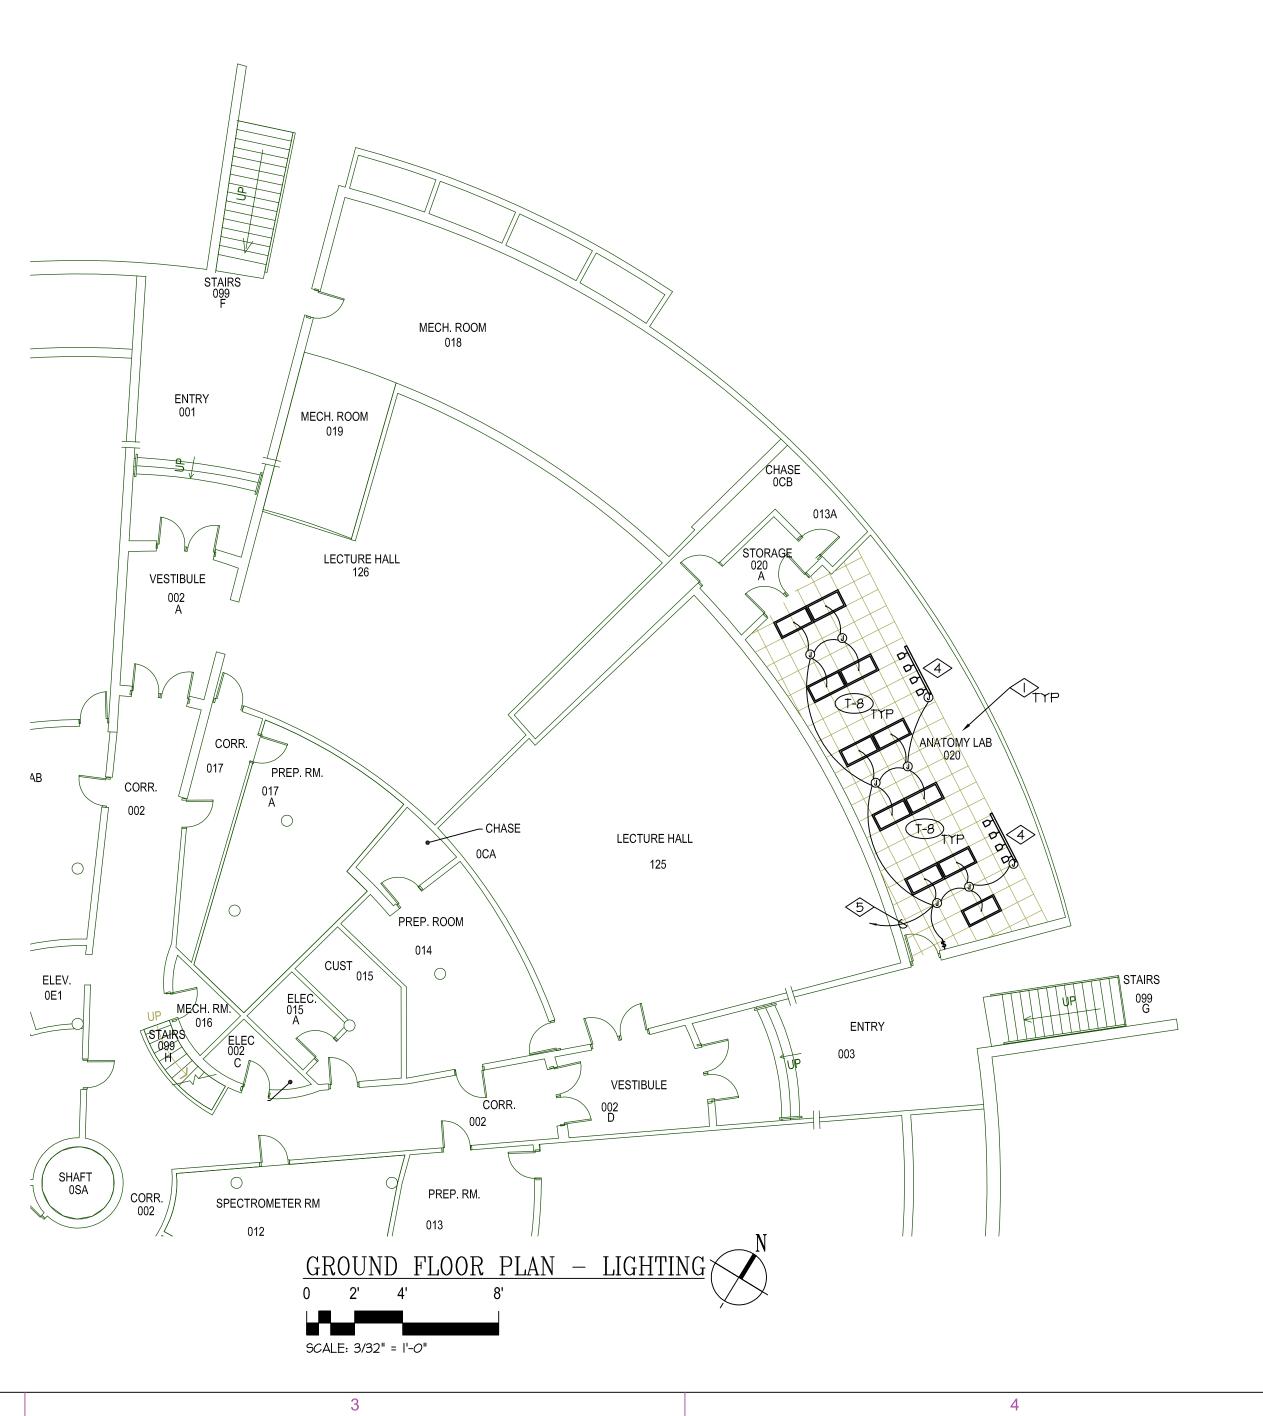
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DEE101-ALT





- REMOVE THE EXISTING TEMPORARY LIGHT FIXTURES AND LIGHT SWITCHES IN ANATOMY LAB 020. REMOVE EXISTING CONDUCTORS ALL THE WAY BACK TO THEIR ORIGINATION POINTS. UTILIZE EXISTING CONDUIT AND J-BOXES AS POSSIBLE. REMOVE ANY ABANDONED CONDUIT.
- TIE THE NEW MECHANICAL UNITS TO A NEW 25 AMP, 3-POLE CIRCUIT BREAKER INSTALLED IN EXISTING PANEL IN STORAGE ROOM 020A. REFER TO MECHANICAL EQUIPMENT SCHEDULE FOR MORE INFORMATION.
- TIE THE NEW MECHANICAL UNITS TO A NEW 90 AMP, 3-POLE CIRCUIT BREAKER INSTALLED IN EXISTING PANEL "MI". PROVIDE MOUNTING HARDWARE AS REQUIRED. REFER TO MECHANICAL EQUIPMENT SCHEDULE FOR MORE INFORMATION.
- INSTALL THE EXISTING LIGHT FIXTURES IN THE APPROXIMATE LOCATION SHOWN ON THE NEW CEILING. TIE TO THE EXISTING LIGHTING CIRCUIT.
- TIE TO THE EXISTING LIGHTING CIRCUIT THROUGH NEW LIGHT SWITCH INSTALLED IN EXISTING LOCATION. PROVIDE CONDUIT, CONDUCTOR, J-BOXES, ETC. FOR A COMPLETE INSTALLATION.





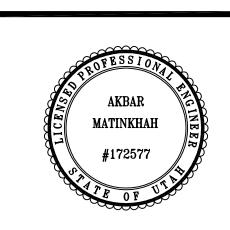
MHTN ARCHITECTS, INC.

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LIND LECTURE HALL REMODEL WEBER STATE UNIVERSITY OGDEN CAMPUS OGDEN, UTAH STATE DIVISION OF FACILITIES CONSTRUCTION & MANAGEMENT DECM PROJECT NO. 04040810



MHTN	PROJECT NO.	2005605 ECE PROJECT NO. 302
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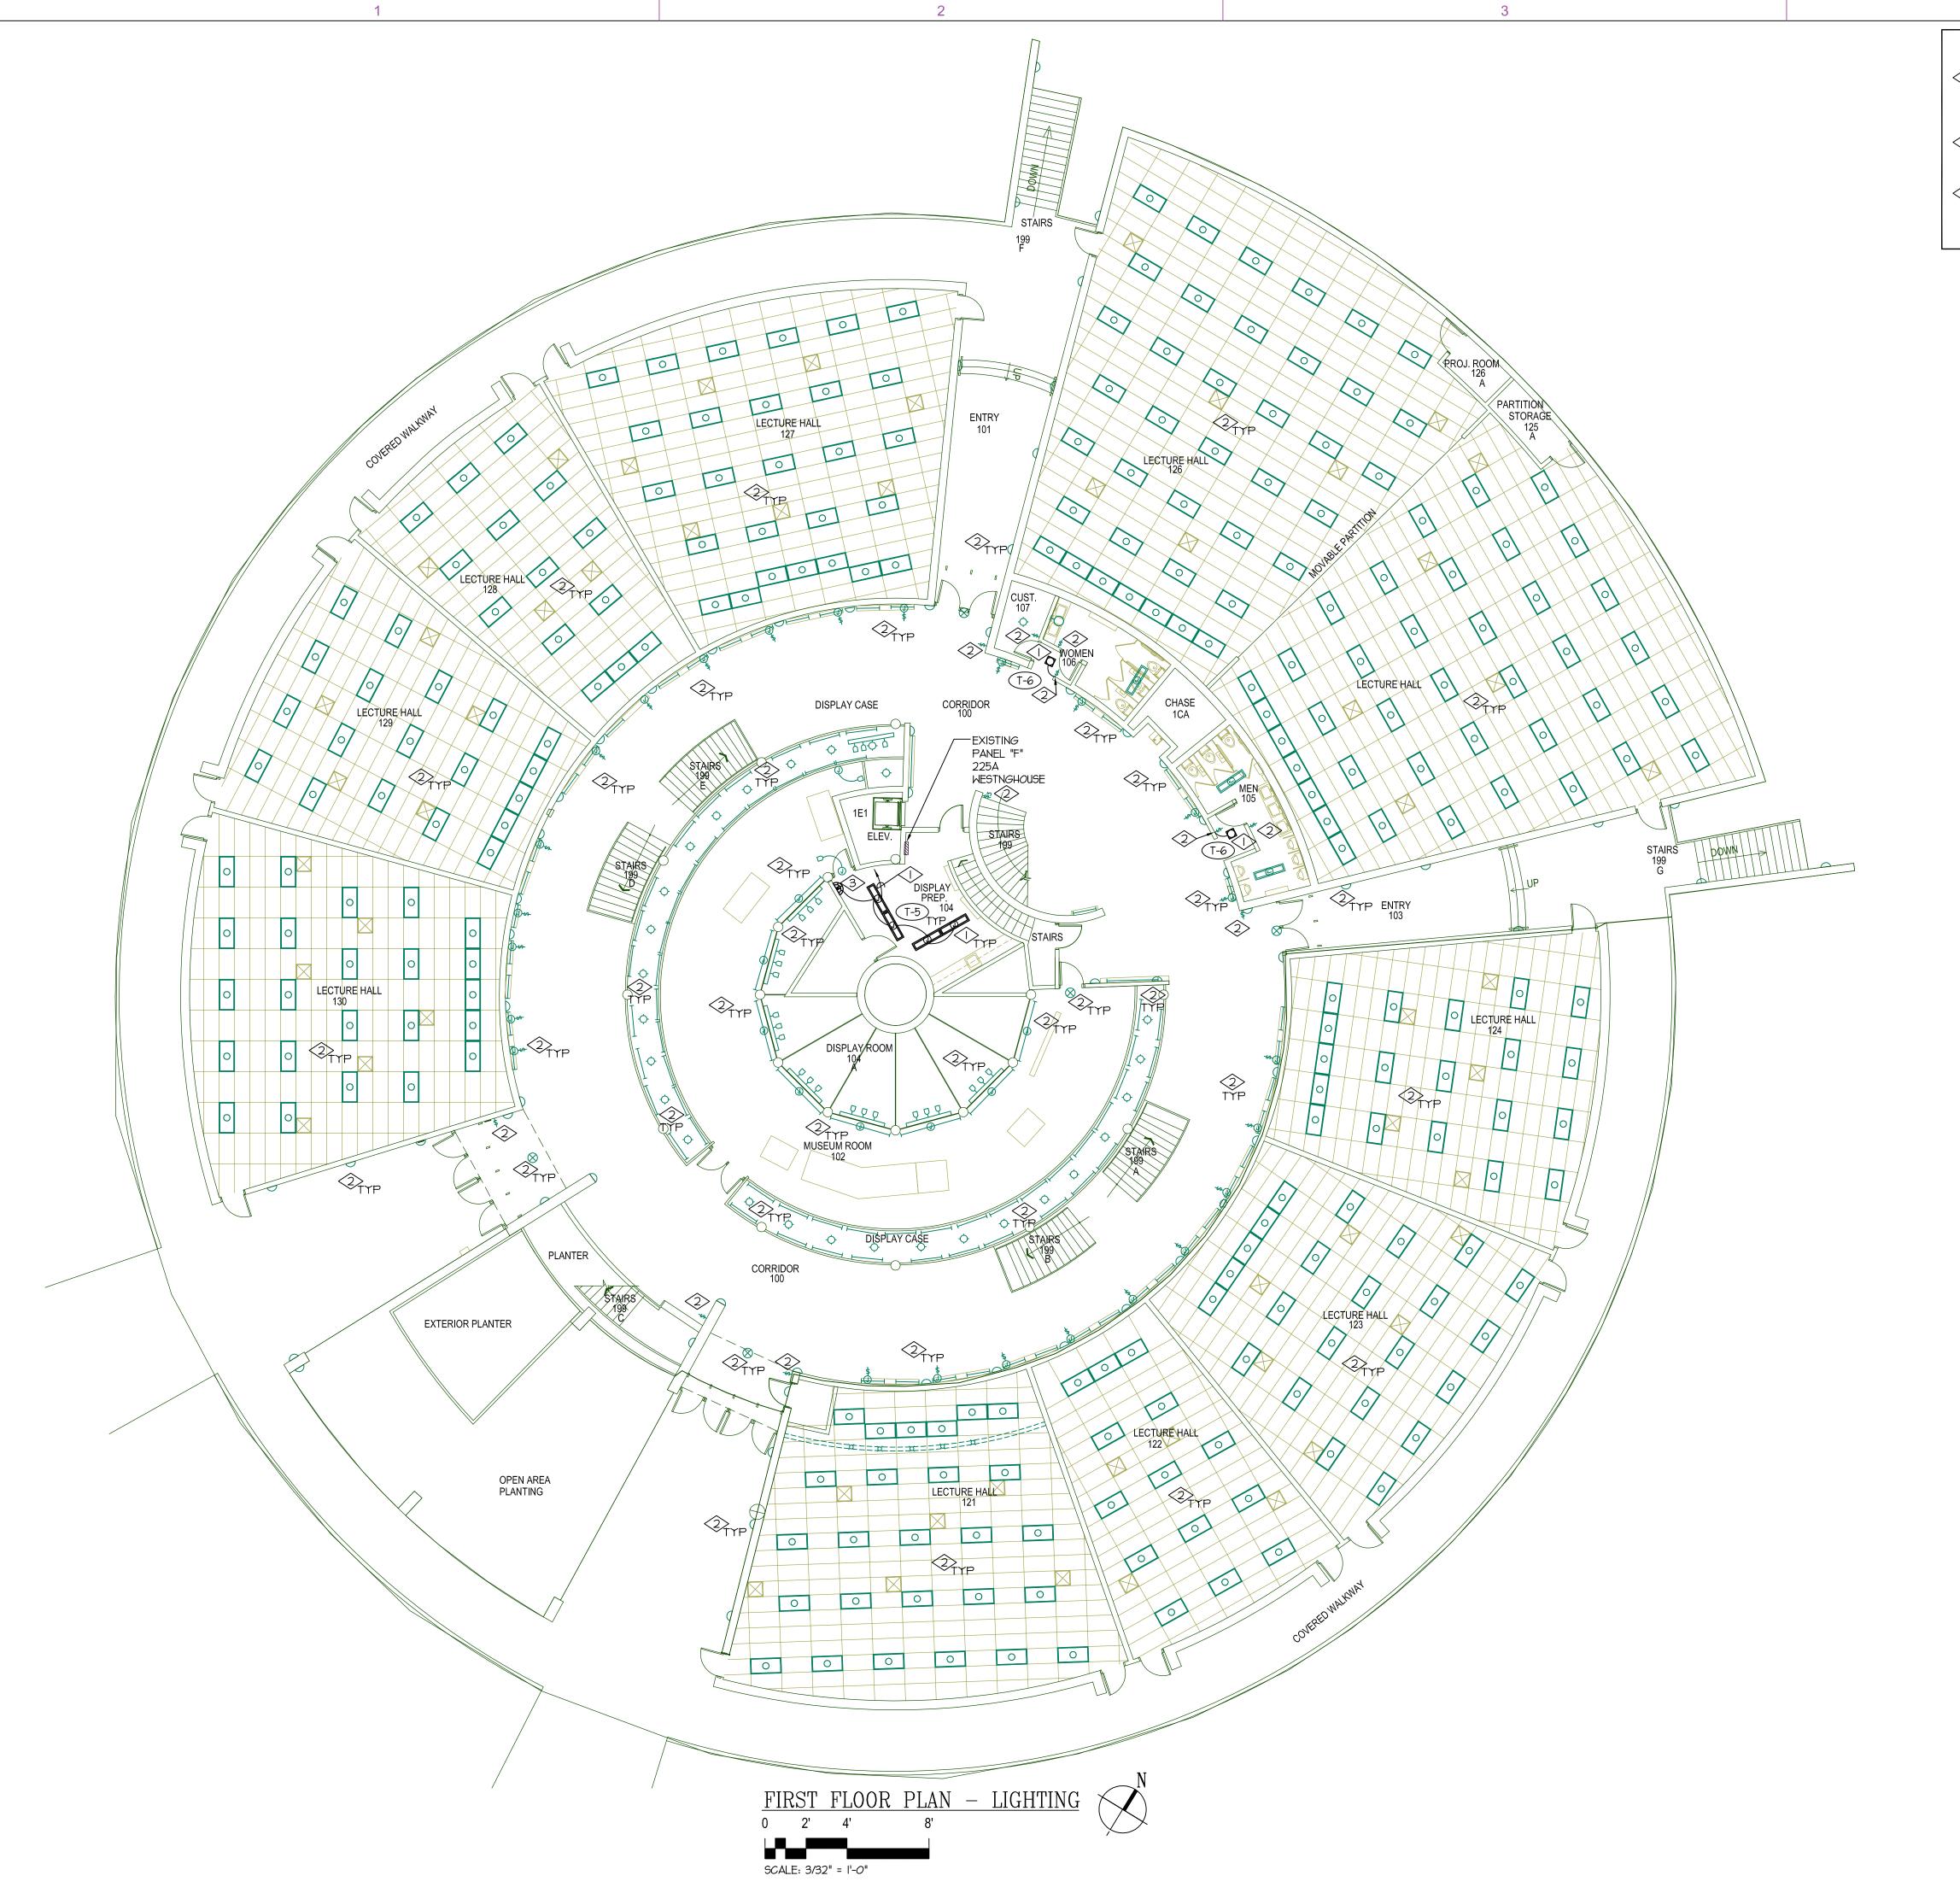
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GROUND FLOOR PLAN - LIGHTING & ELECTRICAL

CONSTRUCTION DOCUMENTS

NUMBER

EL100



- FURNISH AND INSTALL NEW LIGHT FIXTURE IN THE SAME LOCATIONS AS EXISTING FIXTURES. TIE TO THE EXISTING LIGHTING CIRCUIT THROUGH NEW LIGHT SWITCHES INSTALLED IN EXISTING LOCATIONS.
- EXISTING LIGHT FIXTURE & LIGHT SWITCHES TO REMAIN. MAKE ANY MODIFICATIONS REQUIRED TO MAINTAIN CIRCUIT INTEGRITY.
- FURNISH AND INSTALL A WALL MOUNTED MOTION SENSOR WITH OUTO-OFF SWITCH IN APPROXIMATE LOCATION SHOWN.
  WATTSTOPPER CAT #WI-200. COLOR BY ARCHITECT PROVIDE CONDUIT AND CONDUCTORS FOR A COMPLETE INSTALLATION.



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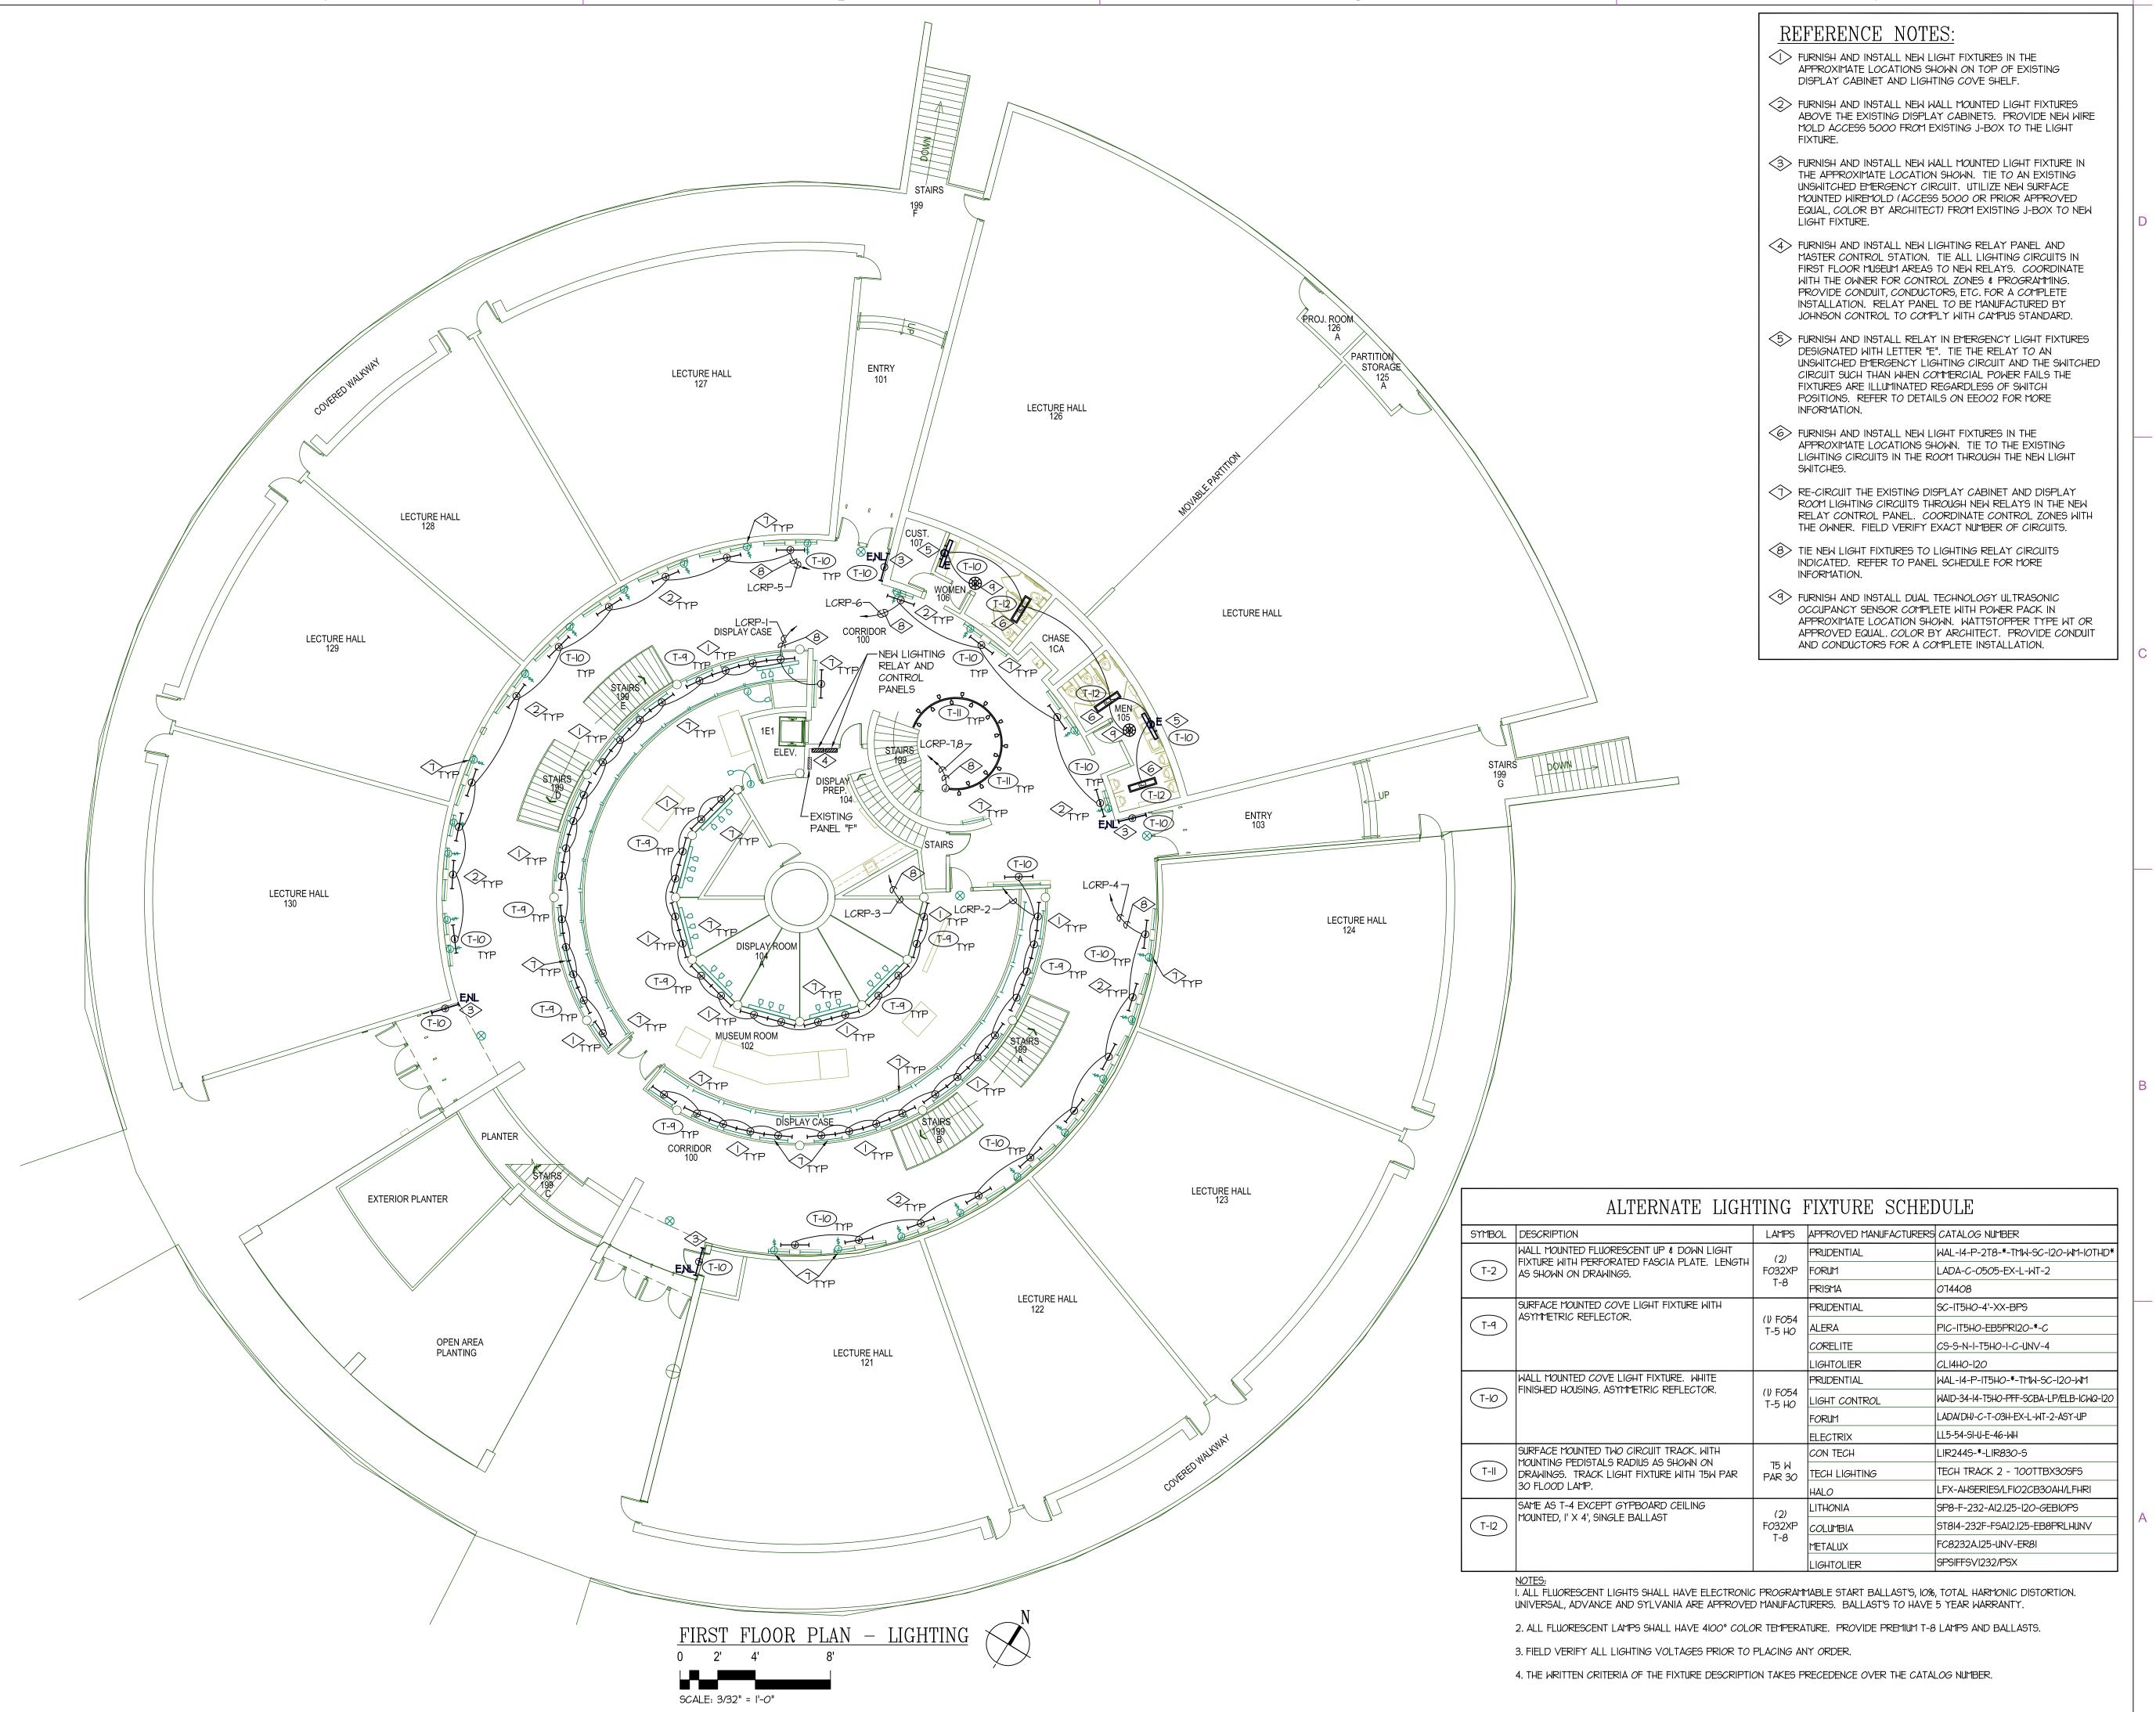
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FIRST FLOOR PLAN LIGHTING

CONSTRUCTION DOCUMENTS

NUMBER

EL101





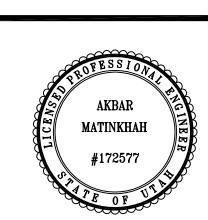
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LIND LECTURE HALL REMODEL WEBER STATE UNIVERSITY OGDEN CAMPUS OGDEN, UTAI STATE DIVISION OF FACILITIES CONSTRUCTION & MANAGEMENT DECM PROJECT NO. 04040810



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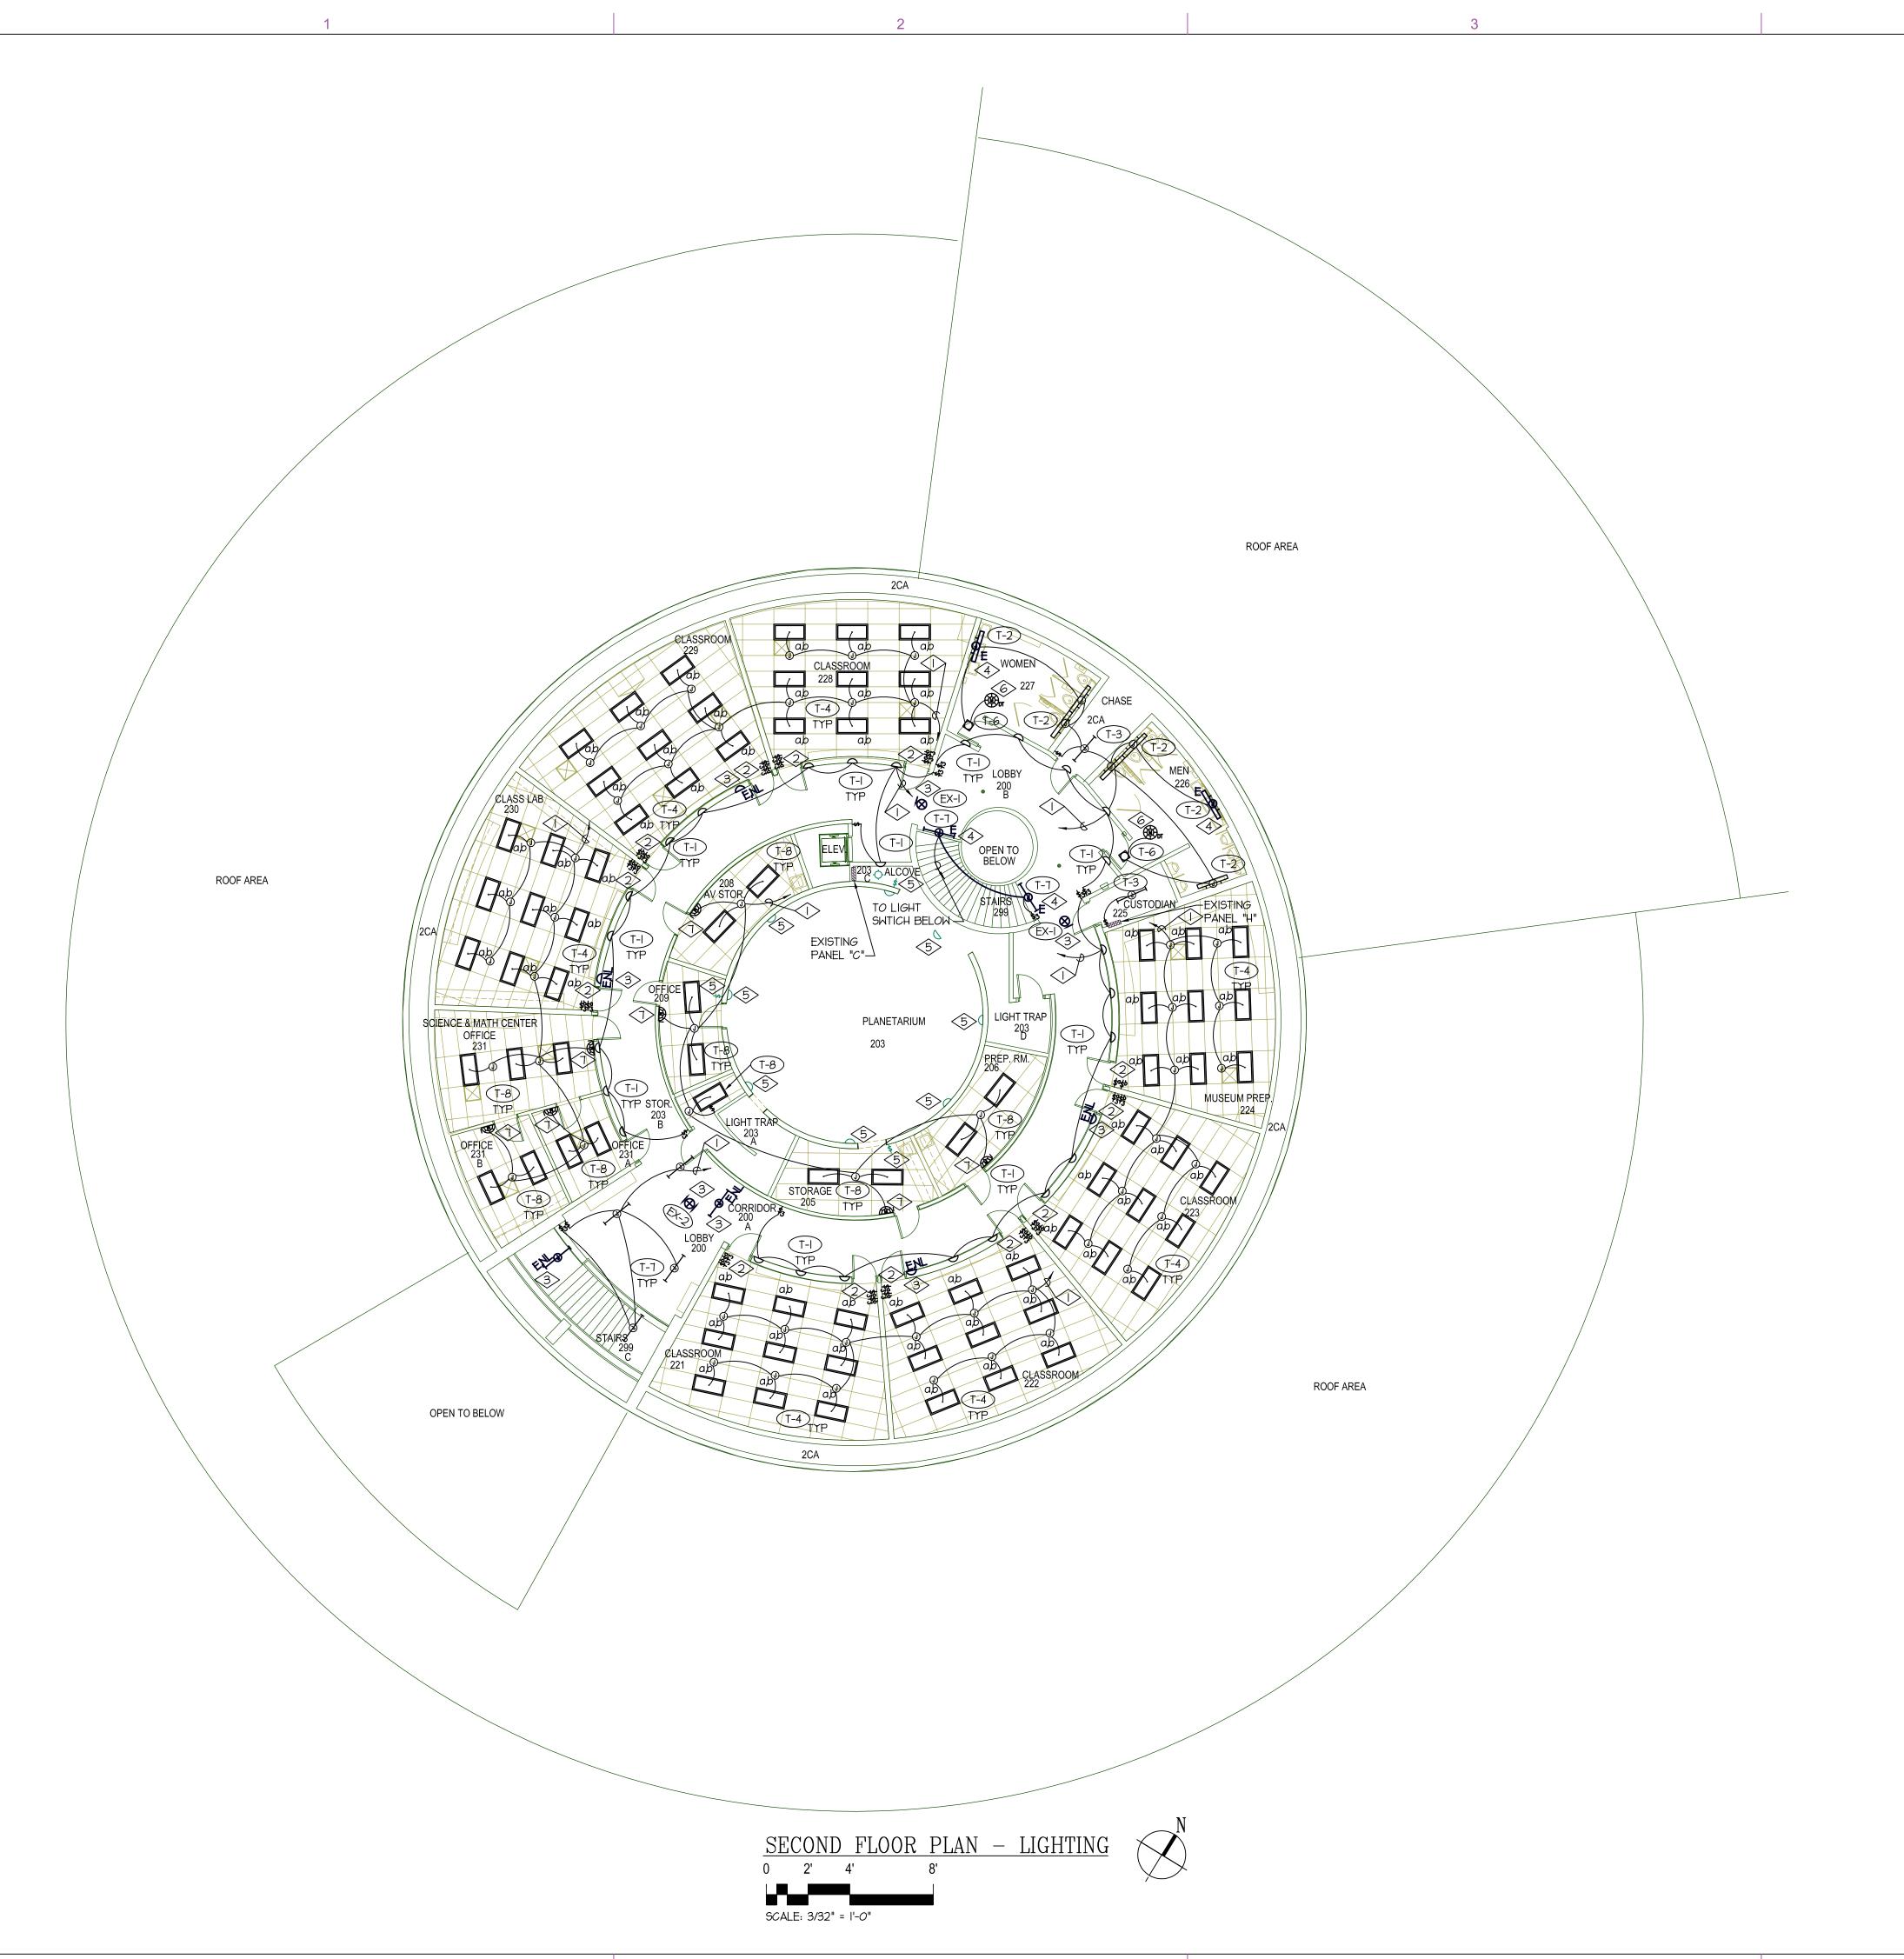
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ALTERNATE FIRST FLOOR PLAN - LIGHTING

CONSTRUCTION DOCUMENTS

T NUMBER

EL101-ALT



- TIE TO AN EXISTING 20 AMP, I-POLE LIGHTING CIRCUIT CIRCUIT BREAKER MADE AVAILABLE DURING DEMOLITION THROUGH THE NEW LIGHT SWITCHES SHOWN.
- 2> FURNISH AND INSTALL NEW LIGHT SWITCHES IN THE APPROXIMATE LOCATION SHOWN. LOWER CASE LETTERS INDICATE SWITCHING ZONES.
- 3> TIE THE EMERGENCY NIGHT LIGHT FIXTURES AND THE EXIT SIGNS TO AN EXISTING UNSWITCHED EMERGENCY LIGHTING CIRCUIT MADE AVAILABLE DURING DEMOLITION.
- 4> FURNISH AND INSTALL RELAY IN EMERGENCY LIGHT FIXTURES DESIGNATED WITH LETTER "E". TIE THE RELAY TO AN UNSWITCHED EMERGENCY LIGHTING CIRCUIT AND THE SWITCHED CIRCUIT SUCH THAN WHEN COMMERCIAL POWER FAILS THE FIXTURES ARE ILLUMINATED REGARDLESS OF SWITCH POSITIONS. REFER TO DETAILS ON EEOO2 FOR MORE INFORMATION.
- (5) EXISTING LIGHT FIXTURES AND SWITCHES ARE TO REMAIN. MAKE MODIFICATIONS TO MAINTAIN CIRCUIT INTEGRITY.
- 6 FURNISH AND INSTALL DUAL TECHNOLOGY ULTRASONIC OCCUPANCY SENSOR COMPLETE WITH POWER PACK IN APPROXIMATE LOCATION SHOWN. WATTSTOPPER TYPE WT OR APPROVED EQUAL. COLOR BY ARCHITECT. PROVIDE CONDUIT AND CONDUCTORS FOR A COMPLETE INSTALLATION.
- T> FURNISH AND INSTALL A WALL MOUNTED MOTION SENSOR WITH OUTO-OFF SWITCH IN APPROXIMATE LOCATION SHOWN. WATTSTOPPER CAT #WI-200. COLOR BY ARCHITECT PROVIDE CONDUIT AND CONDUCTORS FOR A COMPLETE INSTALLATION.



MHTN ARCHITECTS, INC.

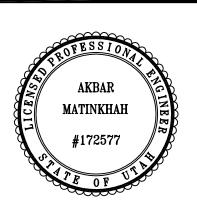
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### LIND LEC WEBER S' OGDEN C, UTAH STATE I FACILITIES CC DFCM PROJEC



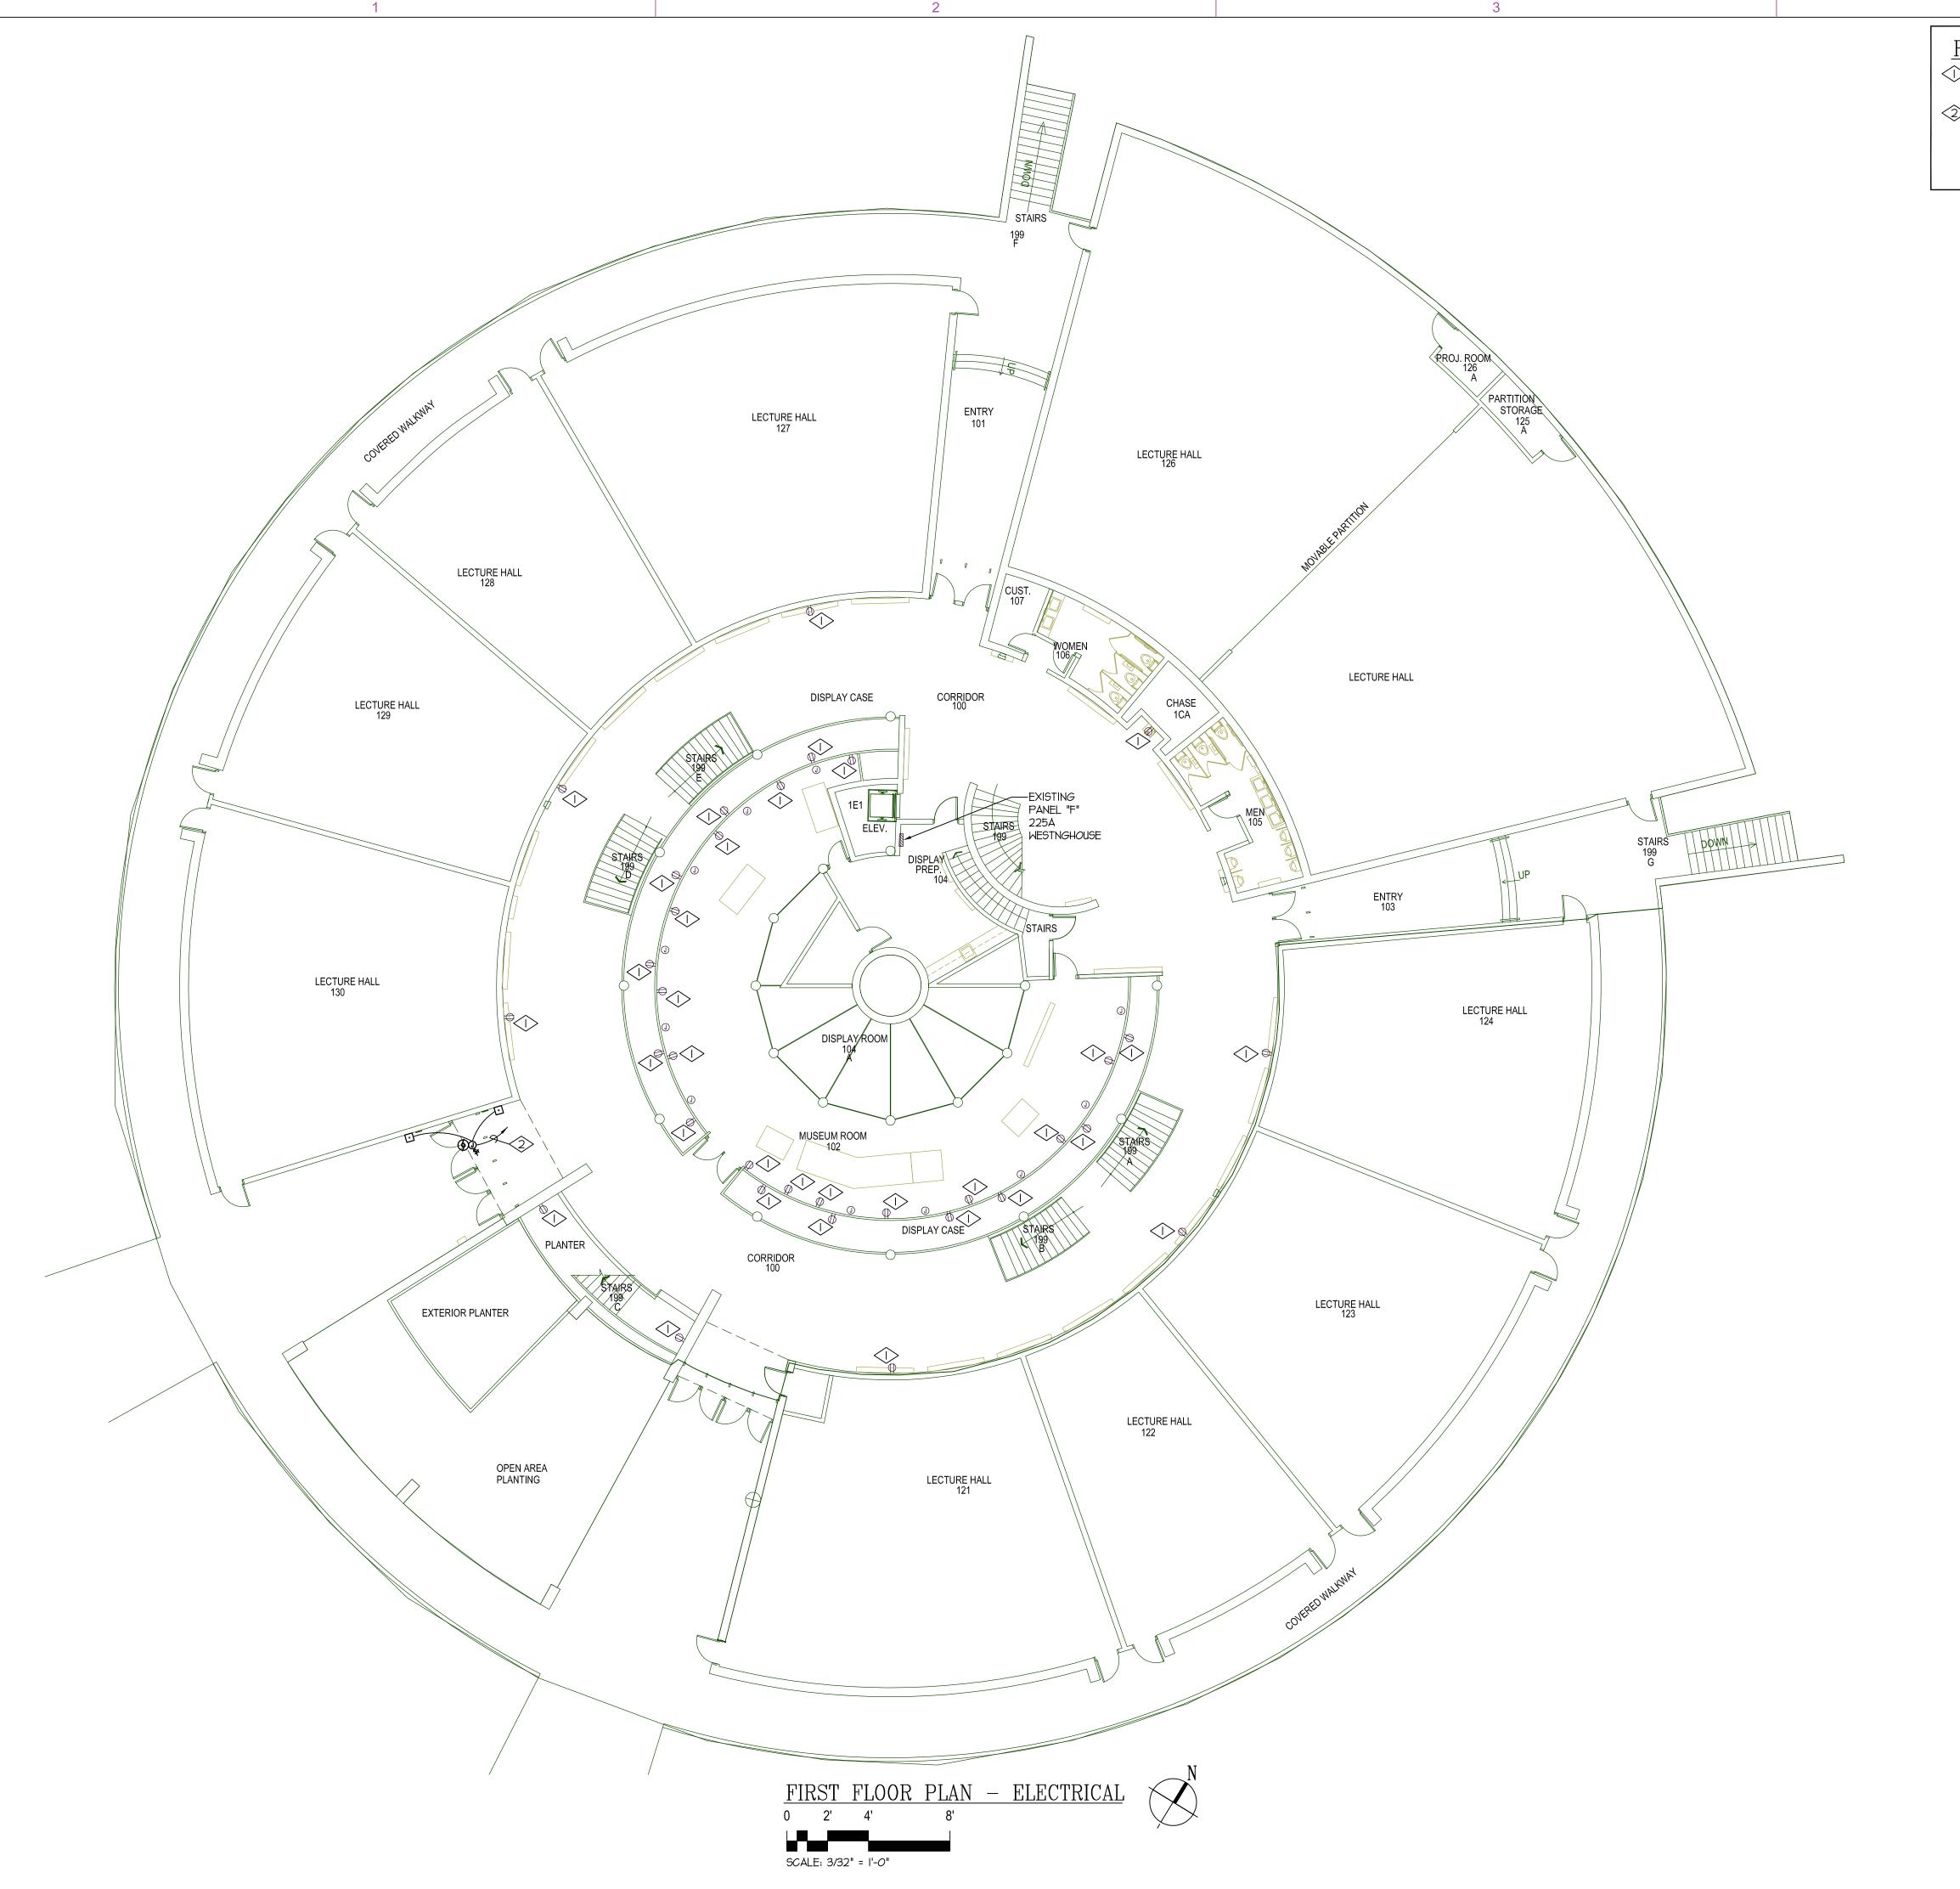
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SECOND FLOOR PLAN LIGHTING

CONSTRUCTION DOCUMENTS

EL102



- EXISTING OUTLETS TO REMAIN. MAKE ANY MODIFICATIONS REQUIRED TO MAINTAIN CIRCUIT INTEGRITY.
- TIE NEW AUTOMATIC DOOR OPERATOR TO A SPARE 20 AMP, I-POLE, CIRCUIT BREAKER IN NEAREST 120/208 VOLT EMERGENCY PANEL WITH AVAILABLE CAPACITY. TIE THE NEW PUSH BUTTON SWITCHES TO MOTOR OPERATOR PER MANUFACTURES RECOMMENDATIONS. PROVIDE SURFACE MOUNTED WIRE MOLD AND SHALLOW J-BOXES AS REQUIRED.



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# LIND LECTURE HALL R WEBER STATE UNIVER OGDEN CAMPUS OG UTAH STATE DIVISION OF FACILITIES CONSTRUCTION & M DFCM PROJECT NO. 04040810



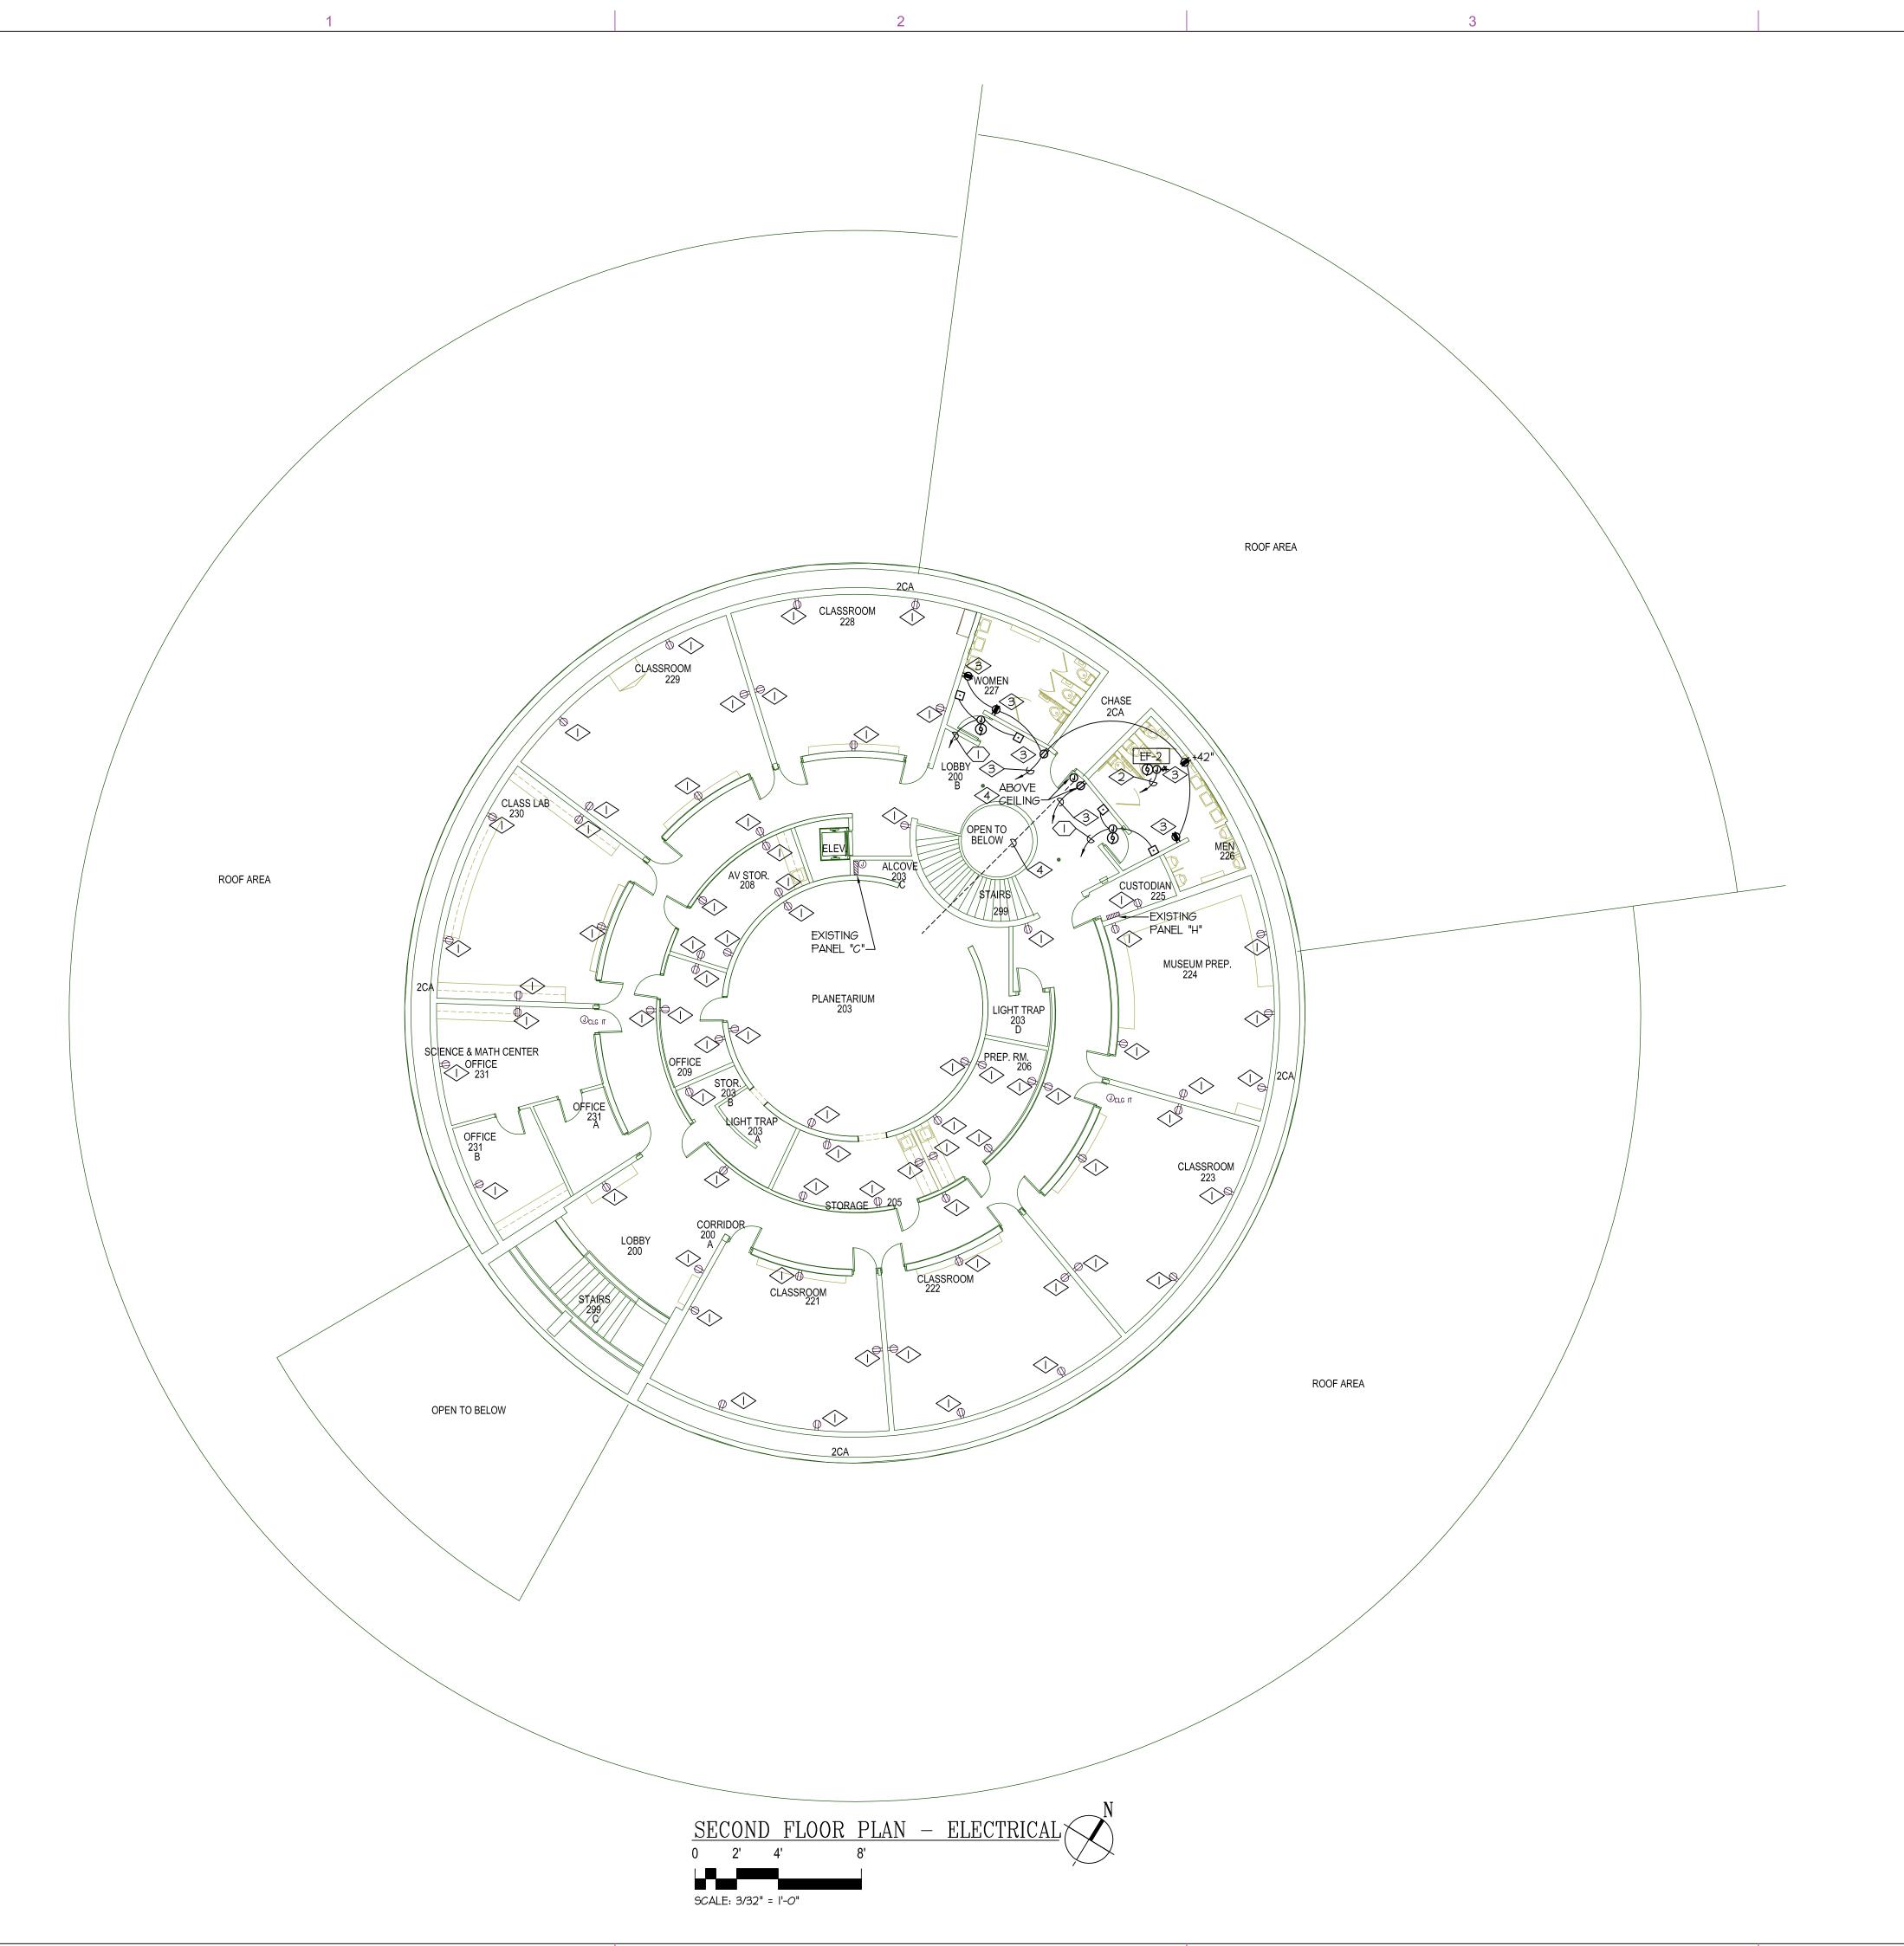
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FIRST FLOOR PLAN ELECTRICAL

CONSTRUCTION DOCUMENTS

EP101



- EXISTING OUTLETS TO REMAIN. MAKE ANY MODIFICATIONS REQUIRED TO MAINTAIN CIRCUIT INTEGRITY.
- TIE THE NEW EXHAUST FAN TO A SPARE 20 AMP, I-POLE CIRCUIT BREAKER IN NEAREST 120/208 VOLT PANEL WITH AVAILABLE CAPACITY. REFER TO TO MECHANICAL EQUIPMENT SCHEDULE FOR MORE INFORMATION.
- (3) FURNISH AND INSTALL NEW OUTLETS IN THE APPROXIMATE LOCATION SHOWN. TIE TO A 20 AMP, I-POLE CIRCUIT BREAKER IN NEAREST 120/208 PANEL WITH AVAILABLE CAPACITY.
- 4> FURNISH AND INSTALL NEW J-BOX AND OUTLET ABOVE THE CEILING FOR FUTURE PROJECTOR. COORDINATE EXACT LOCATION WITH OWNER PRIOR TO ROUGH IN. RUN A 2"
  CONDUIT FROM THE J-BOX INTO THE PLANETARIUM.
  COORDINATE STUB OUT LOCATION WITH THE OWNER. CORE DRILL THE WALL AS REQUIRED.

### ALTERNATE NO. 4 REFERENCE NOTES:

TIE NEW AUTOMATIC DOOR OPERATOR TO A SPARE 20 AMP, I-POLE, CIRCUIT BREAKER IN NEAREST 120/208 VOLT EMERGENCY PANEL WITH AVAILABLE CAPACITY. TIE THE NEW PUSH BUTTON SWITCHES TO MOTOR OPERATOR PER MANUFACTURES RECOMMENDATIONS. PROVIDE CONDUIT AND CONDUCTORS AS REQUIRED.



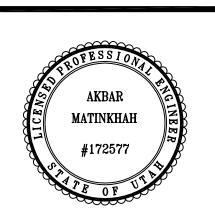
MHTN ARCHITECTS, INC.

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### LIND LECT WEBER S' OGDEN C, UTAH STATE D FACILITIES CO DFCM PROJECT



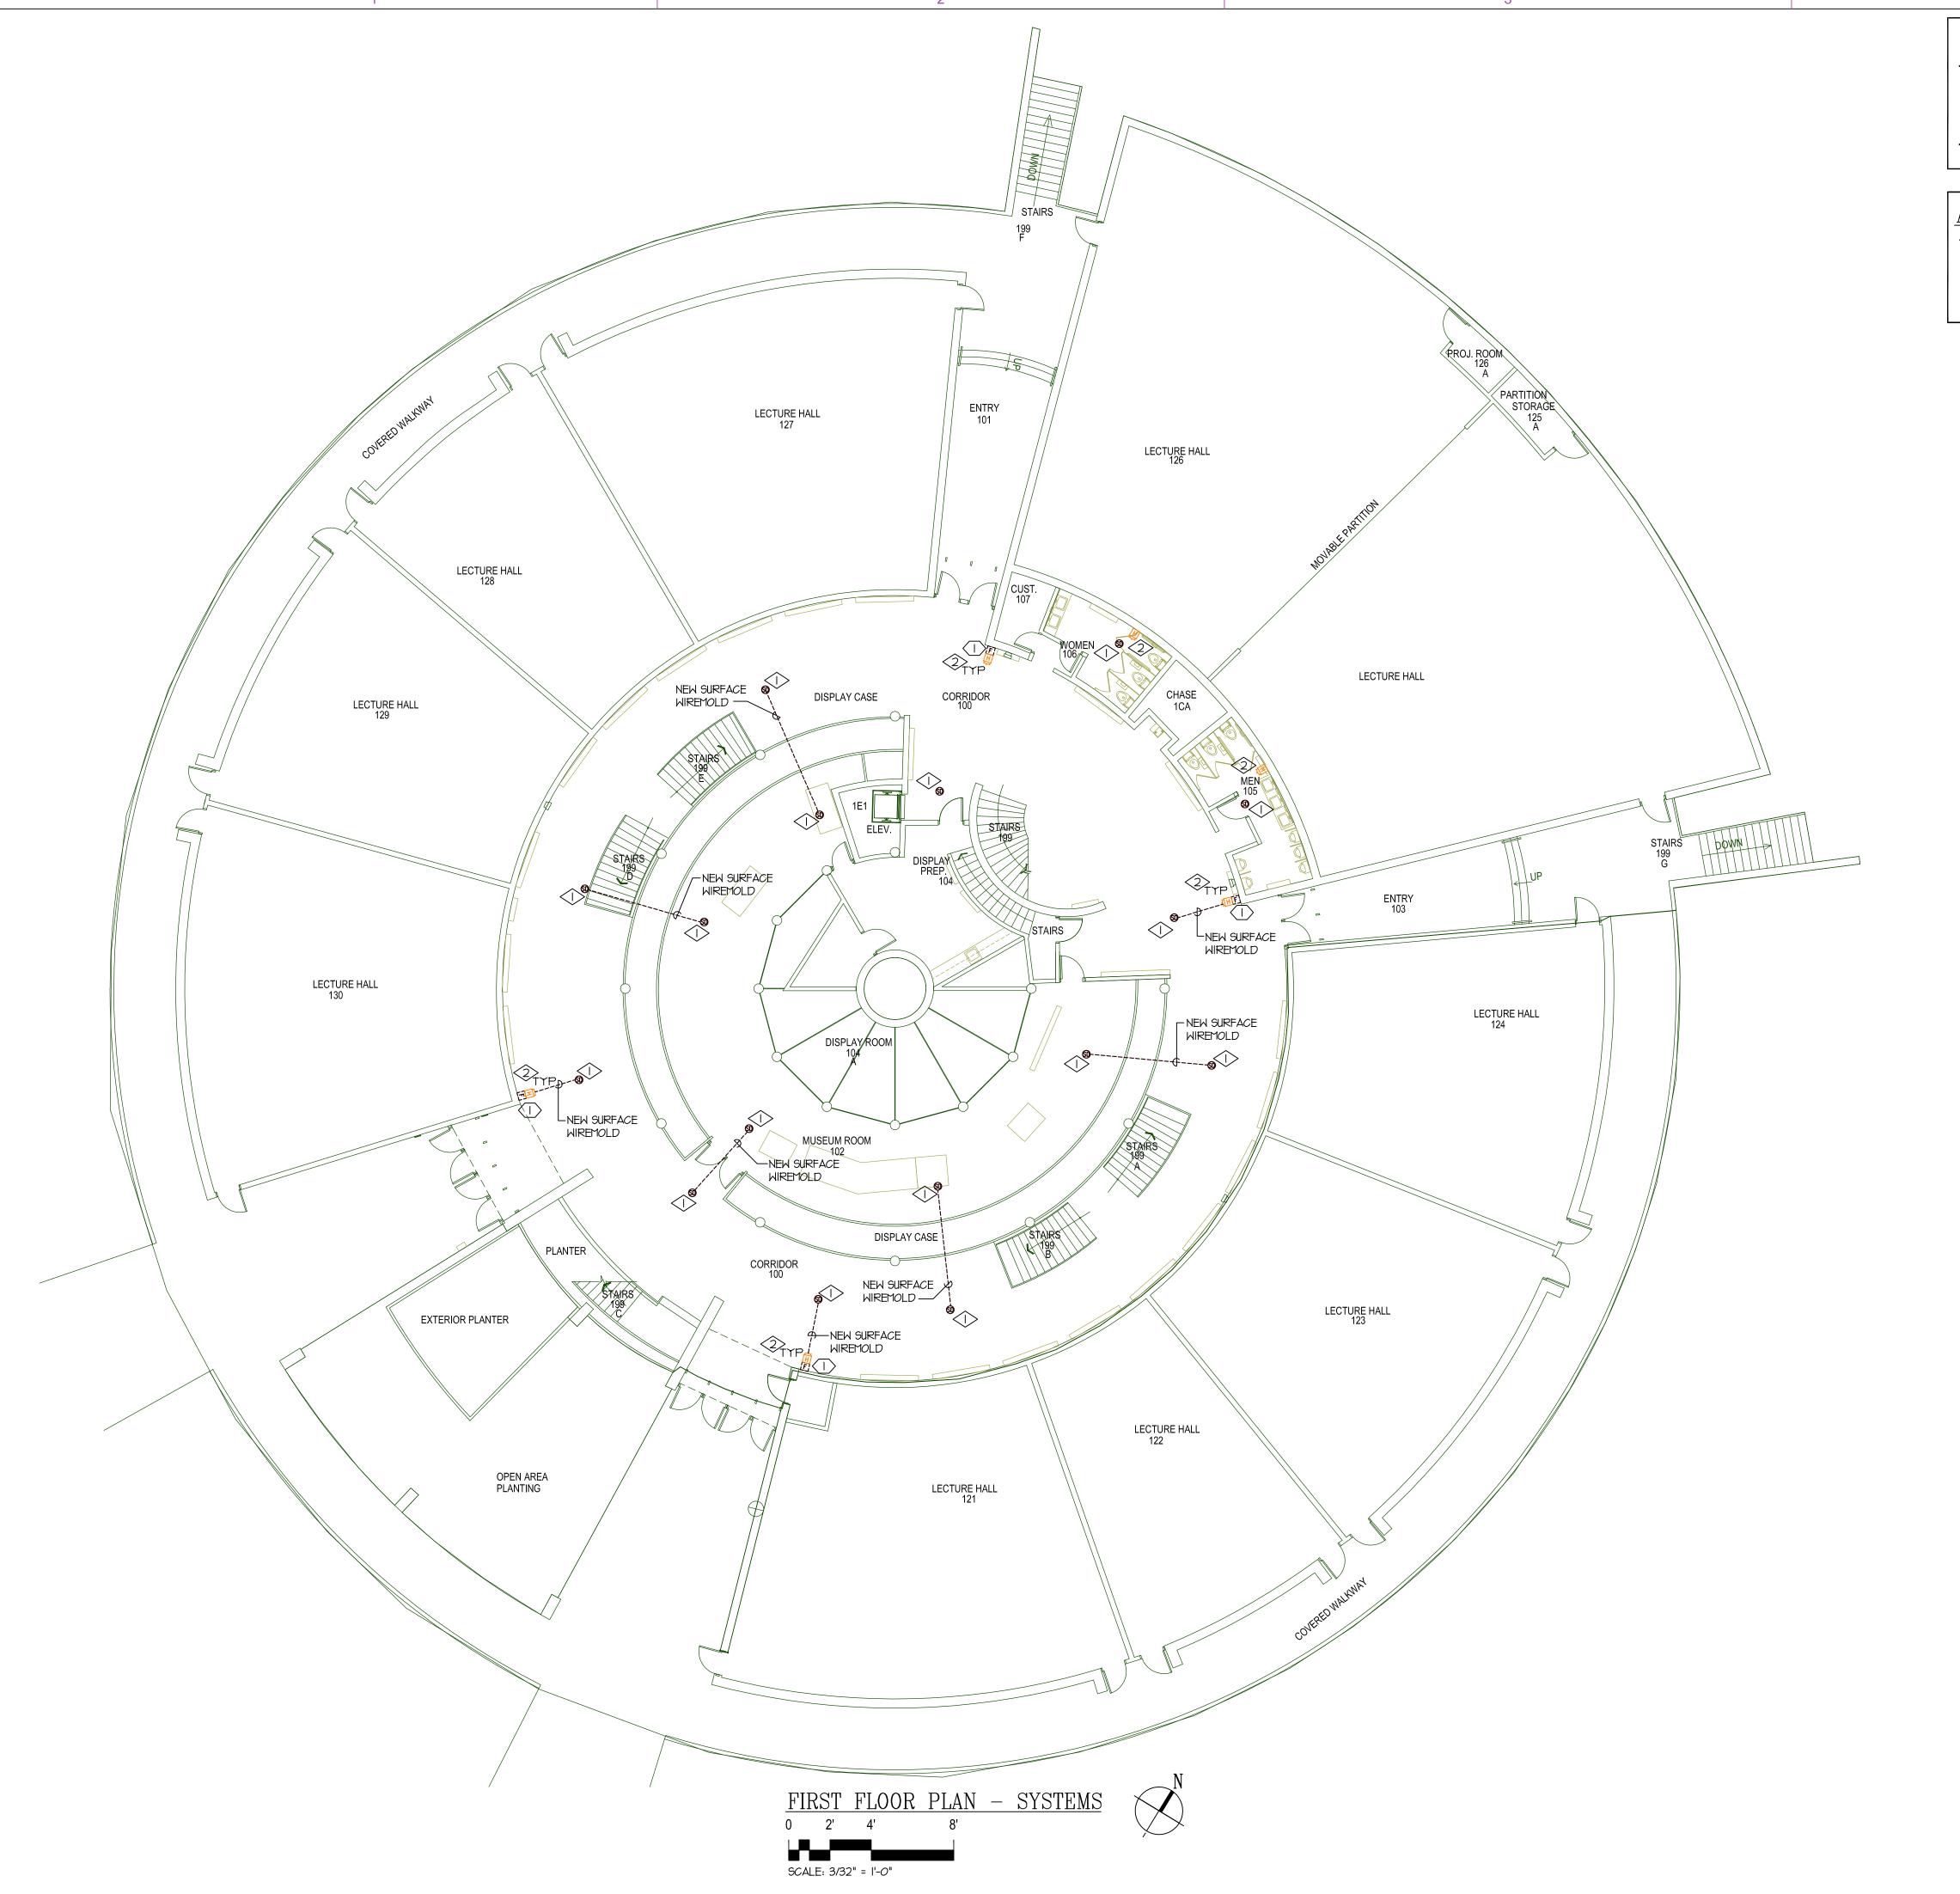
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SECOND FLOOR PLAN ELECTRICAL

CONSTRUCTION DOCUMENTS

EP102



- INSTALL EXISTING SMOKE DETECTORS IN THE LOCATIONS SHOWN. EXTEND EXISTING FIRE ALARM LOOP TO THE NEW LOCATION. UTILIZE EXISTING CONDUIT AS POSSIBLE. PROVIDE SURFACE WIREMOLD, CONDUCTORS, ETC. COORDINATE THIS WORK WITH MOUNTAIN ALARM.
- EXISTING FIRE ALARM DEVICES SHALL REMAIN. MAKE ANY MODIFICATIONS TO MAINTAIN CIRCUIT INTEGRITY.

### ALTERNATE NO. 2 REFERENCE NOTES:

REMOVE THE EXISTING FIRE ALARM MANUAL PULL STATION AND REINSTALL AT 48" A.F.F. TRACE CIRCUIT BACK TO NEAREST REMAINING DEVICES AND FROM THERE EXTEND CONDUCTOR AND CONDUIT TO THE NEW LOCATION. DO NOT SPLICE FIRE ALARM CONDUCTORS.



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### LIND LECTURE HALL REMODEL WEBER STATE UNIVERSITY OGDEN CAMPUS OGDEN, UTAL STATE DIVISION OF FACILITIES CONSTRUCTION & MANAGEMENT DECM PROJECT NO. 04040810



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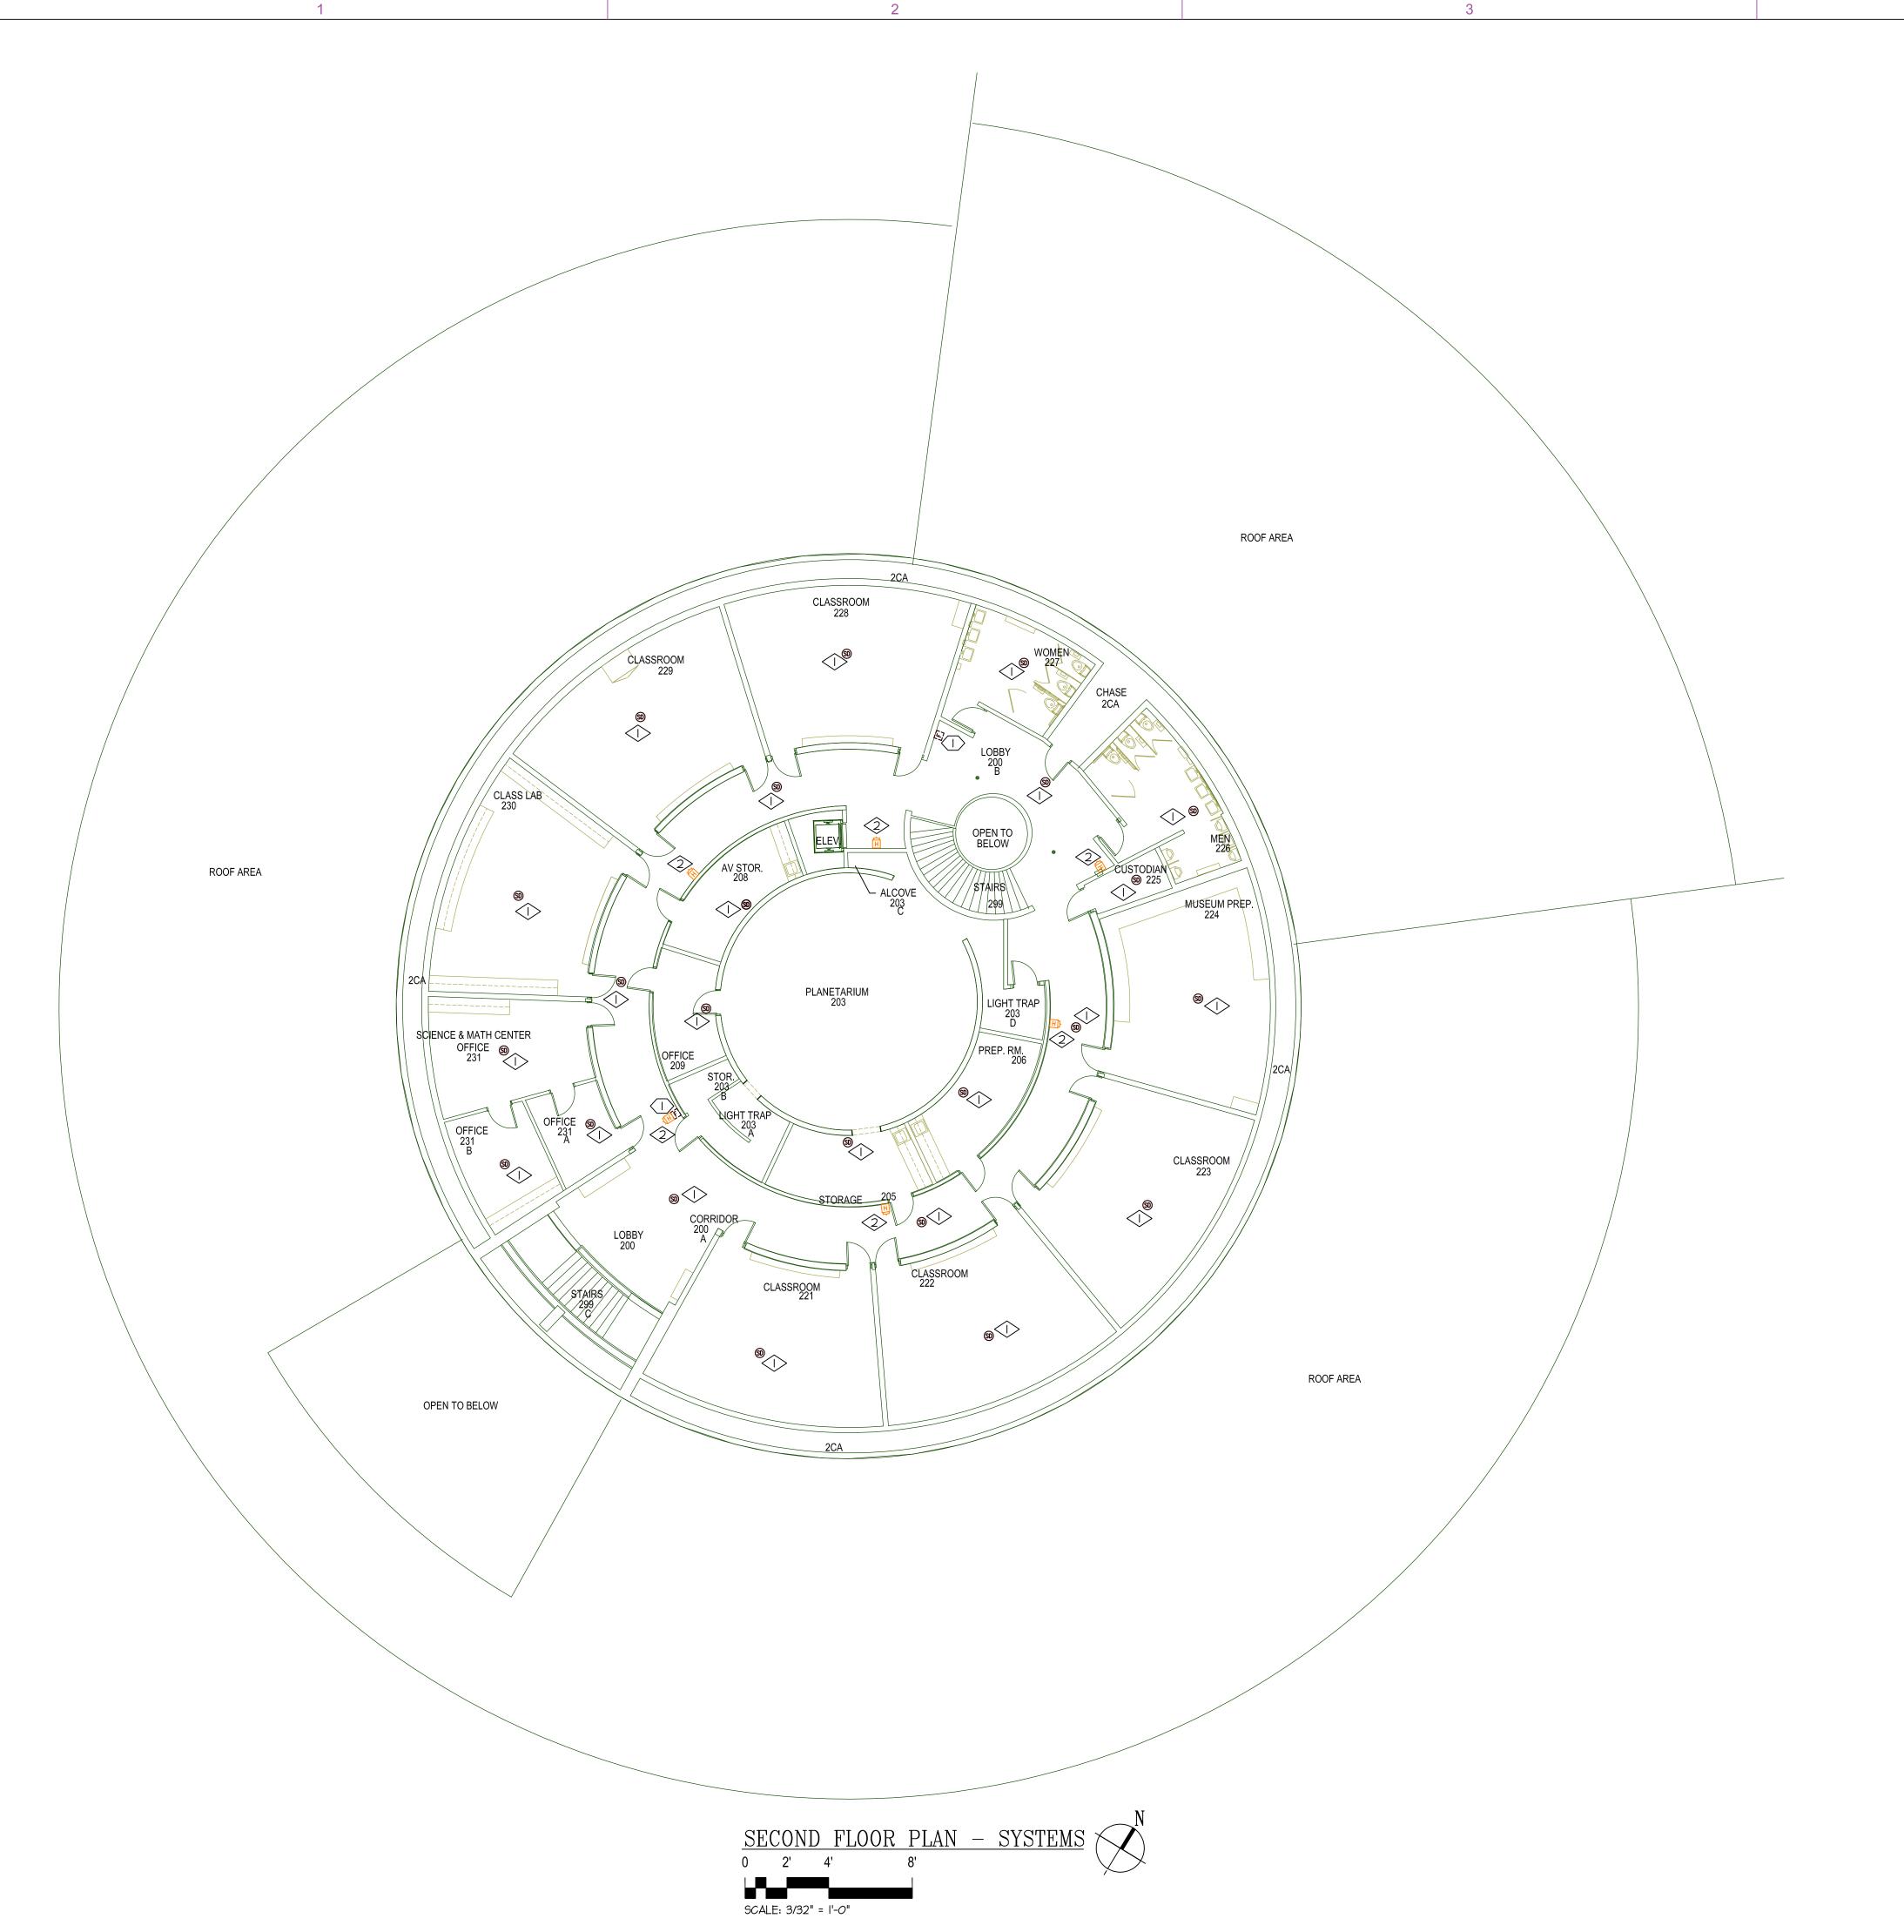
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FIRST FLOOR PLAN SYSTEMS

CONSTRUCTION DOCUMENTS

NUMBER A A

ES101



- INSTALL EXISTING SMOKE DETECTORS IN THE LOCATIONS SHOWN. EXTEND EXISTING FIRE ALARM LOOP TO THE NEW LOCATION. UTILIZE EXISTING CONDUIT AS POSSIBLE. PROVIDE SURFACE WIREMOLD, CONDUCTORS, ETC. COORDINATE THIS WORK WITH MOUNTAIN ALARM.
- EXISTING FIRE ALARM DEVICES SHALL REMAIN. MAKE ANY MODIFICATIONS TO MAINTAIN CIRCUIT INTEGRITY.

### ALTERNATE NO. 2 REFERENCE NOTES:

REMOVE THE EXISTING FIRE ALARM MANUAL PULL STATION AND REINSTALL AT 48" A.F.F. TRACE CIRCUIT BACK TO NEAREST REMAINING DEVICES AND FROM THERE EXTEND CONDUCTOR AND CONDUIT TO THE NEW LOCATION. DO NOT SPLICE FIRE ALARM CONDUCTORS.



MHTN ARCHITECTS, INC.

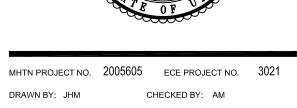
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# LIND LECTURE HALL REMODEL WEBER STATE UNIVERSITY OGDEN CAMPUS OGDEN, UTAH UTAH STATE DIVISION OF FACILITIES CONSTRUCTION & MANAGEMENT DFCM PROJECT NO. 04040810



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SECOND FLOOR PLAN SYSTEMS

CONSTRUCTION DOCUMENTS

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